

BURSAR - REGISTRAR OFFICE EXPANSION -UTS RENOVATIONS

COLUMBIA, SC

OSE Project #H27-Z052-A A/E Project #08040.04 July 23, 2013 issued for CONSTRUCTION DOCUMENTS


Prepared by:




ASSOCIATES, INC.

Architects/Engineers/Planners 1201 Main Street Columbia, South Carolina 29201-3299 tel. 803-256-0000 fax 803-255-7243

KEY PLAN

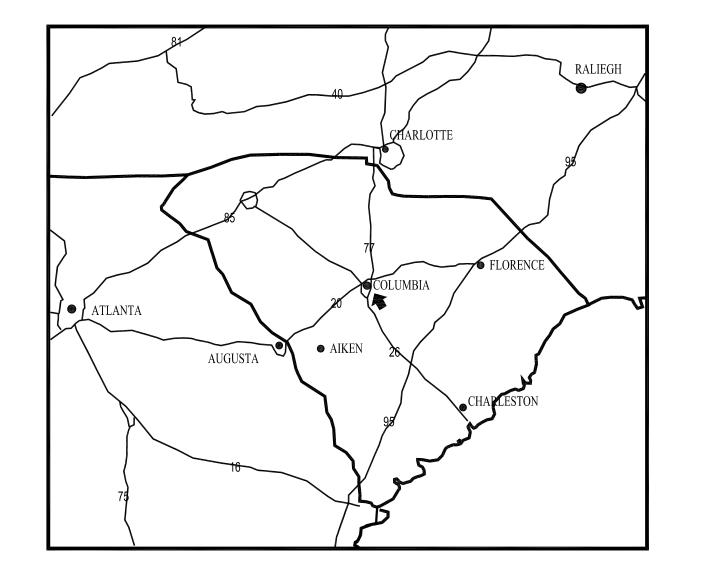

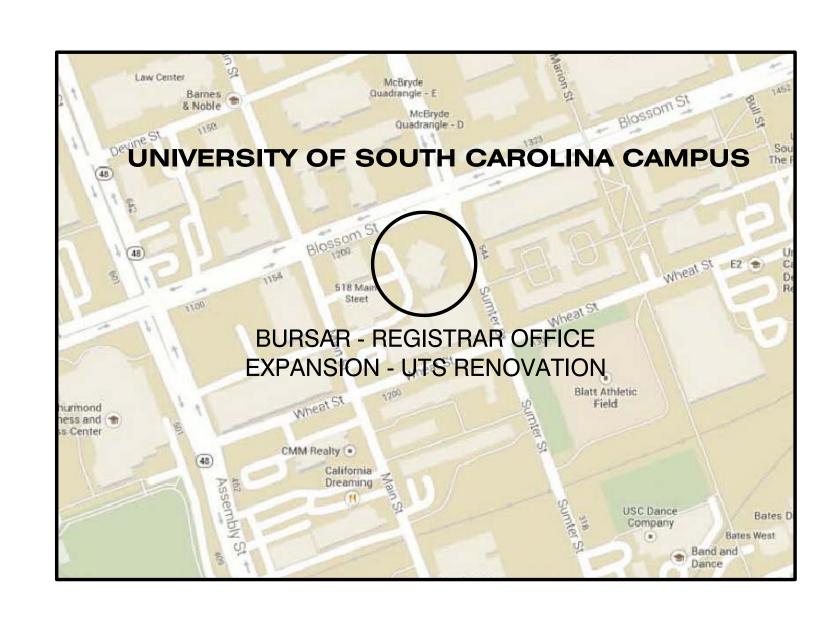

DRAWING INDEX

ARCHITECTURAL

- A0.0 GENERAL NOTES, SYMBOLS AND LEGENDS
 A2.1 FIRST FLOOR DEMOLITION AND RENOVATION PLANS
- A6.0 INTERIOR ELEVATIONS AND MILLWORK DETAILS
- A7.1 FIRST FLOOR REFLECTED CEILING PLAN A8.0 DOOR SCHEDULE, DOOR DETAILS, FINISH SCHEDULE, WINDOW ELEVATIONS AND DETAILS AND MISCELLANEOUS DETAILS,

PLUMBING


PO.0 LEGENDS, SCHEDULES, ABBREVIATIONS, NOTES AND DETAILS
P1.1 PLUMBING FIRST FLOOR DEMOLITION PLAN
P2.1 FIRST FLOOR PLUMBING RENOVATION PLAN


MECHANICAL

M2.1 FIRST FLOOR PLAN HVAC DEMOLITION AND RENOVATION PLAN M7.1 HVAC SCHEDULE AND DETAILS

ELECTRICAL

E0.0 ELECTRICAL SYMBOLS, SCHEDULES AND DETAILS
E1.1 FIRST FLOOR DEMOLITION AND LIGHTING PLAN
E3.1 FIRST FLOOR POWER PLAN

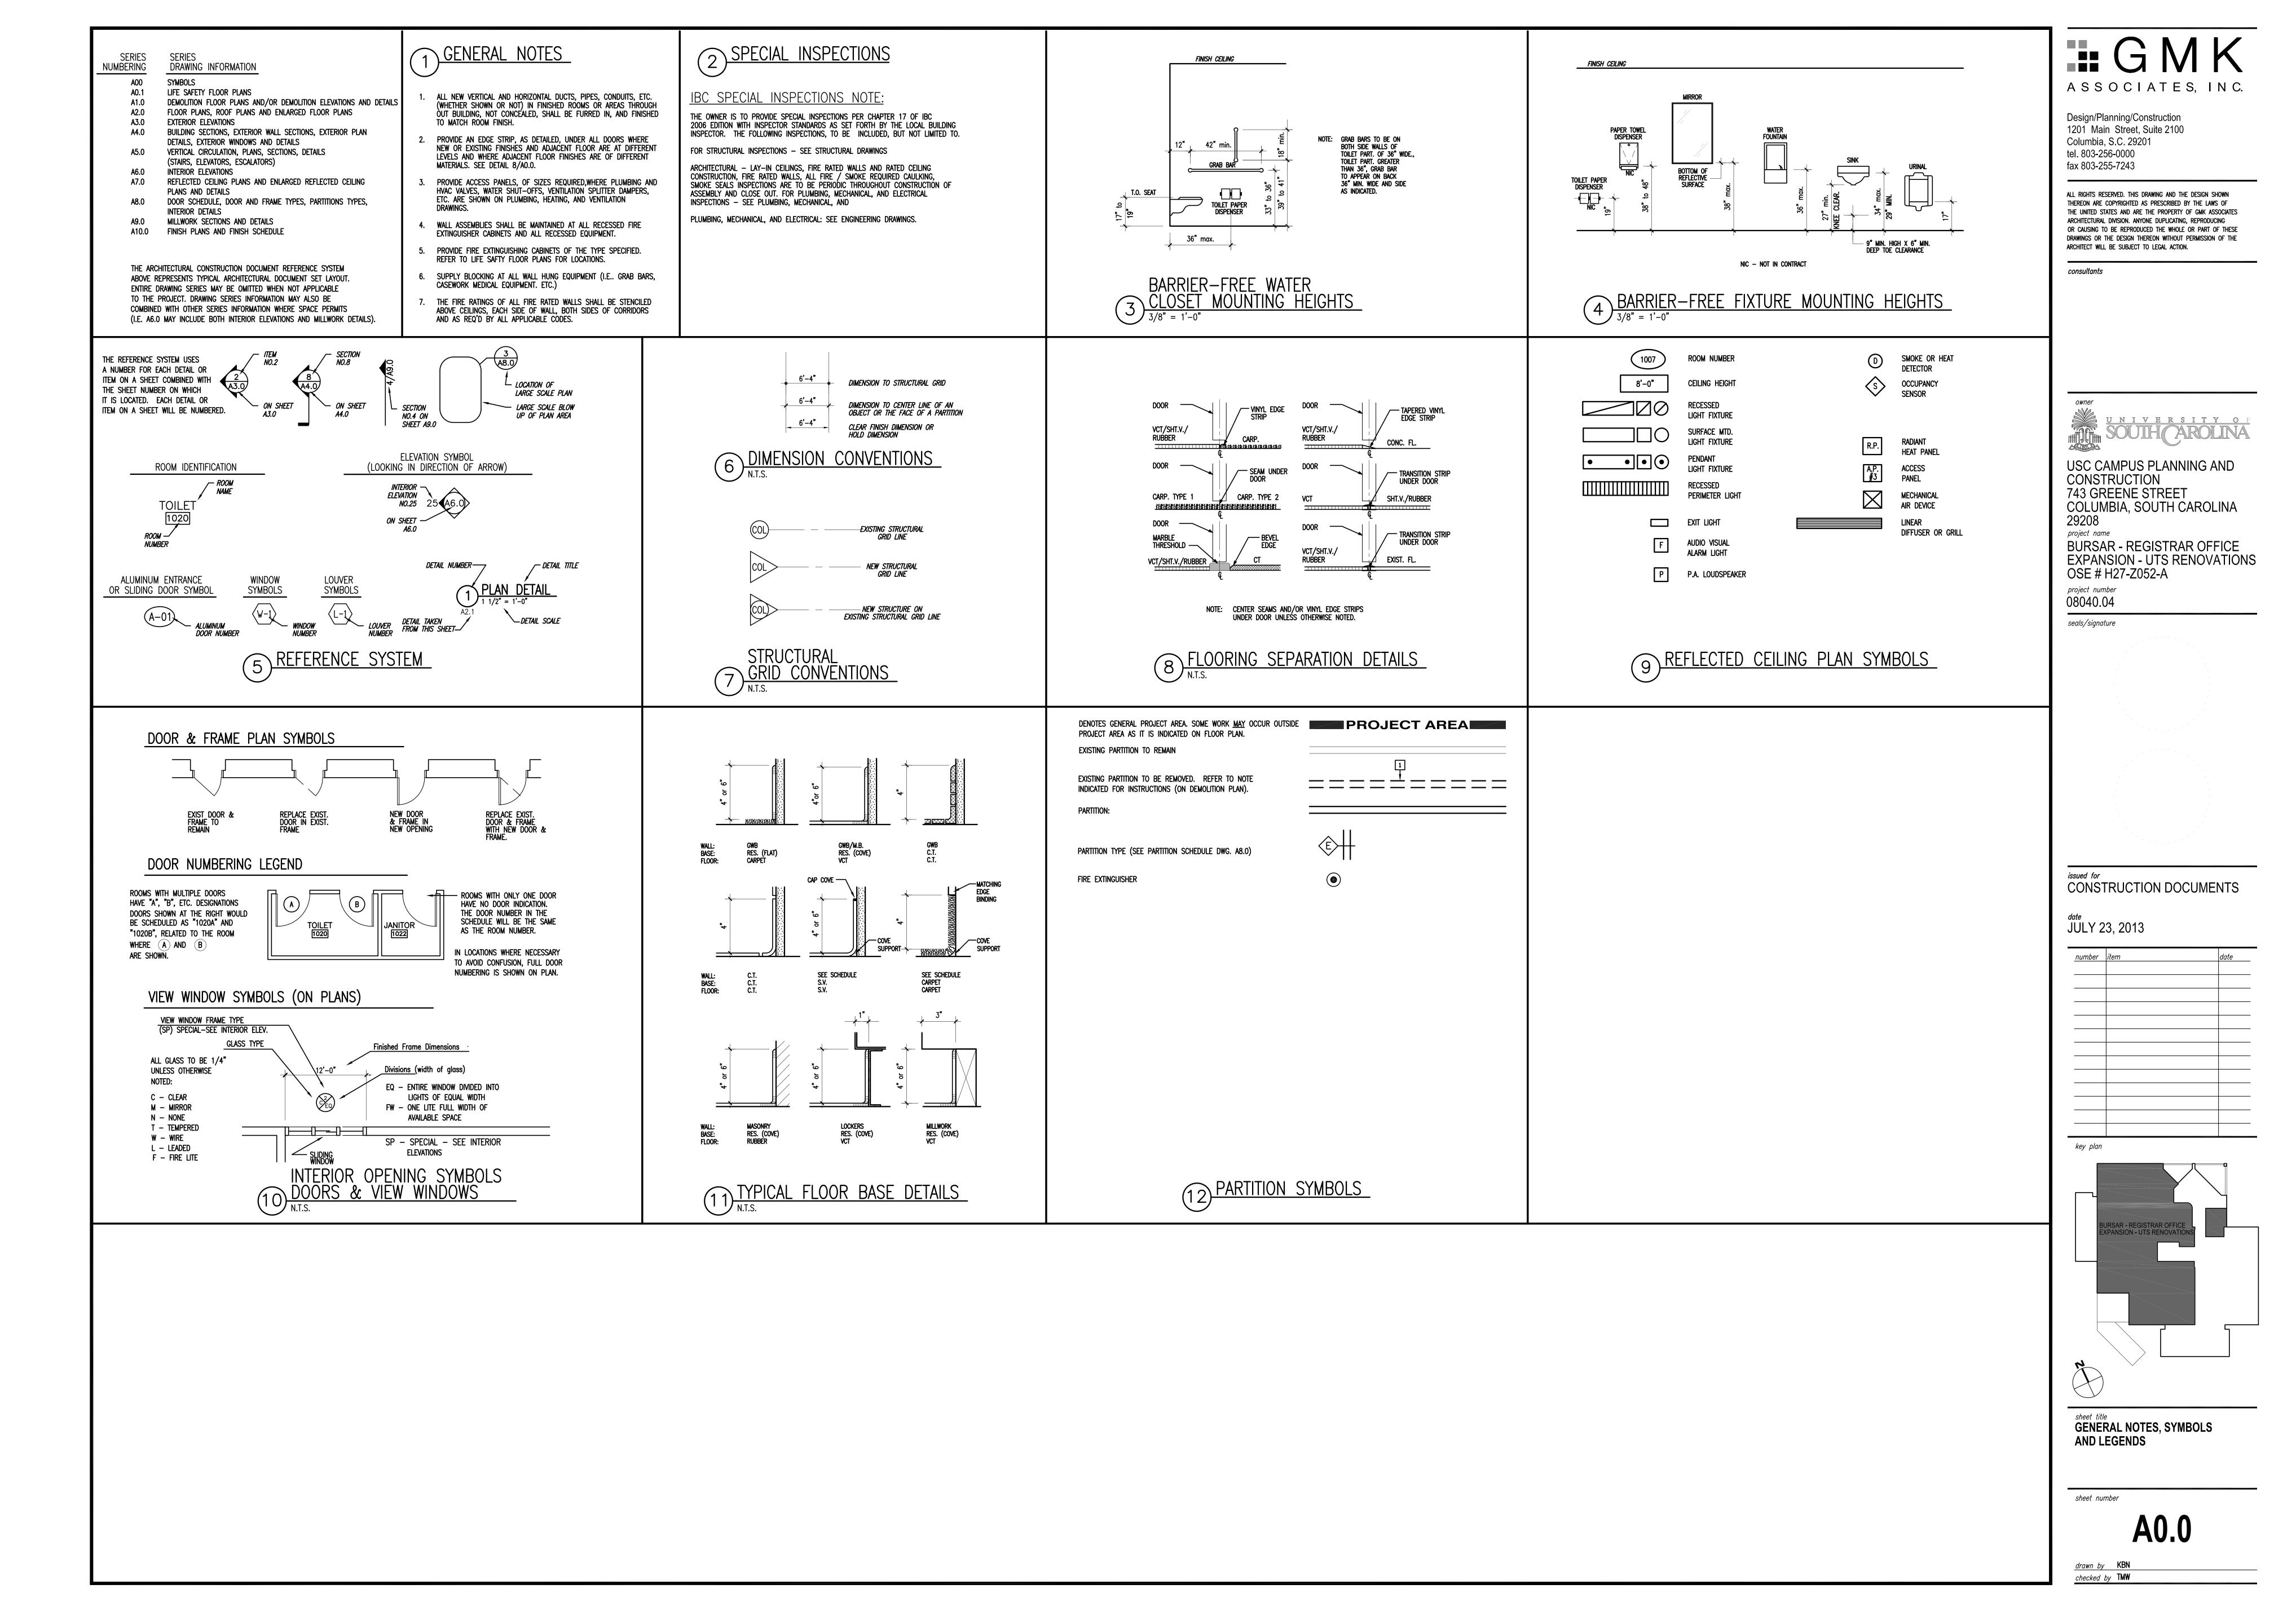

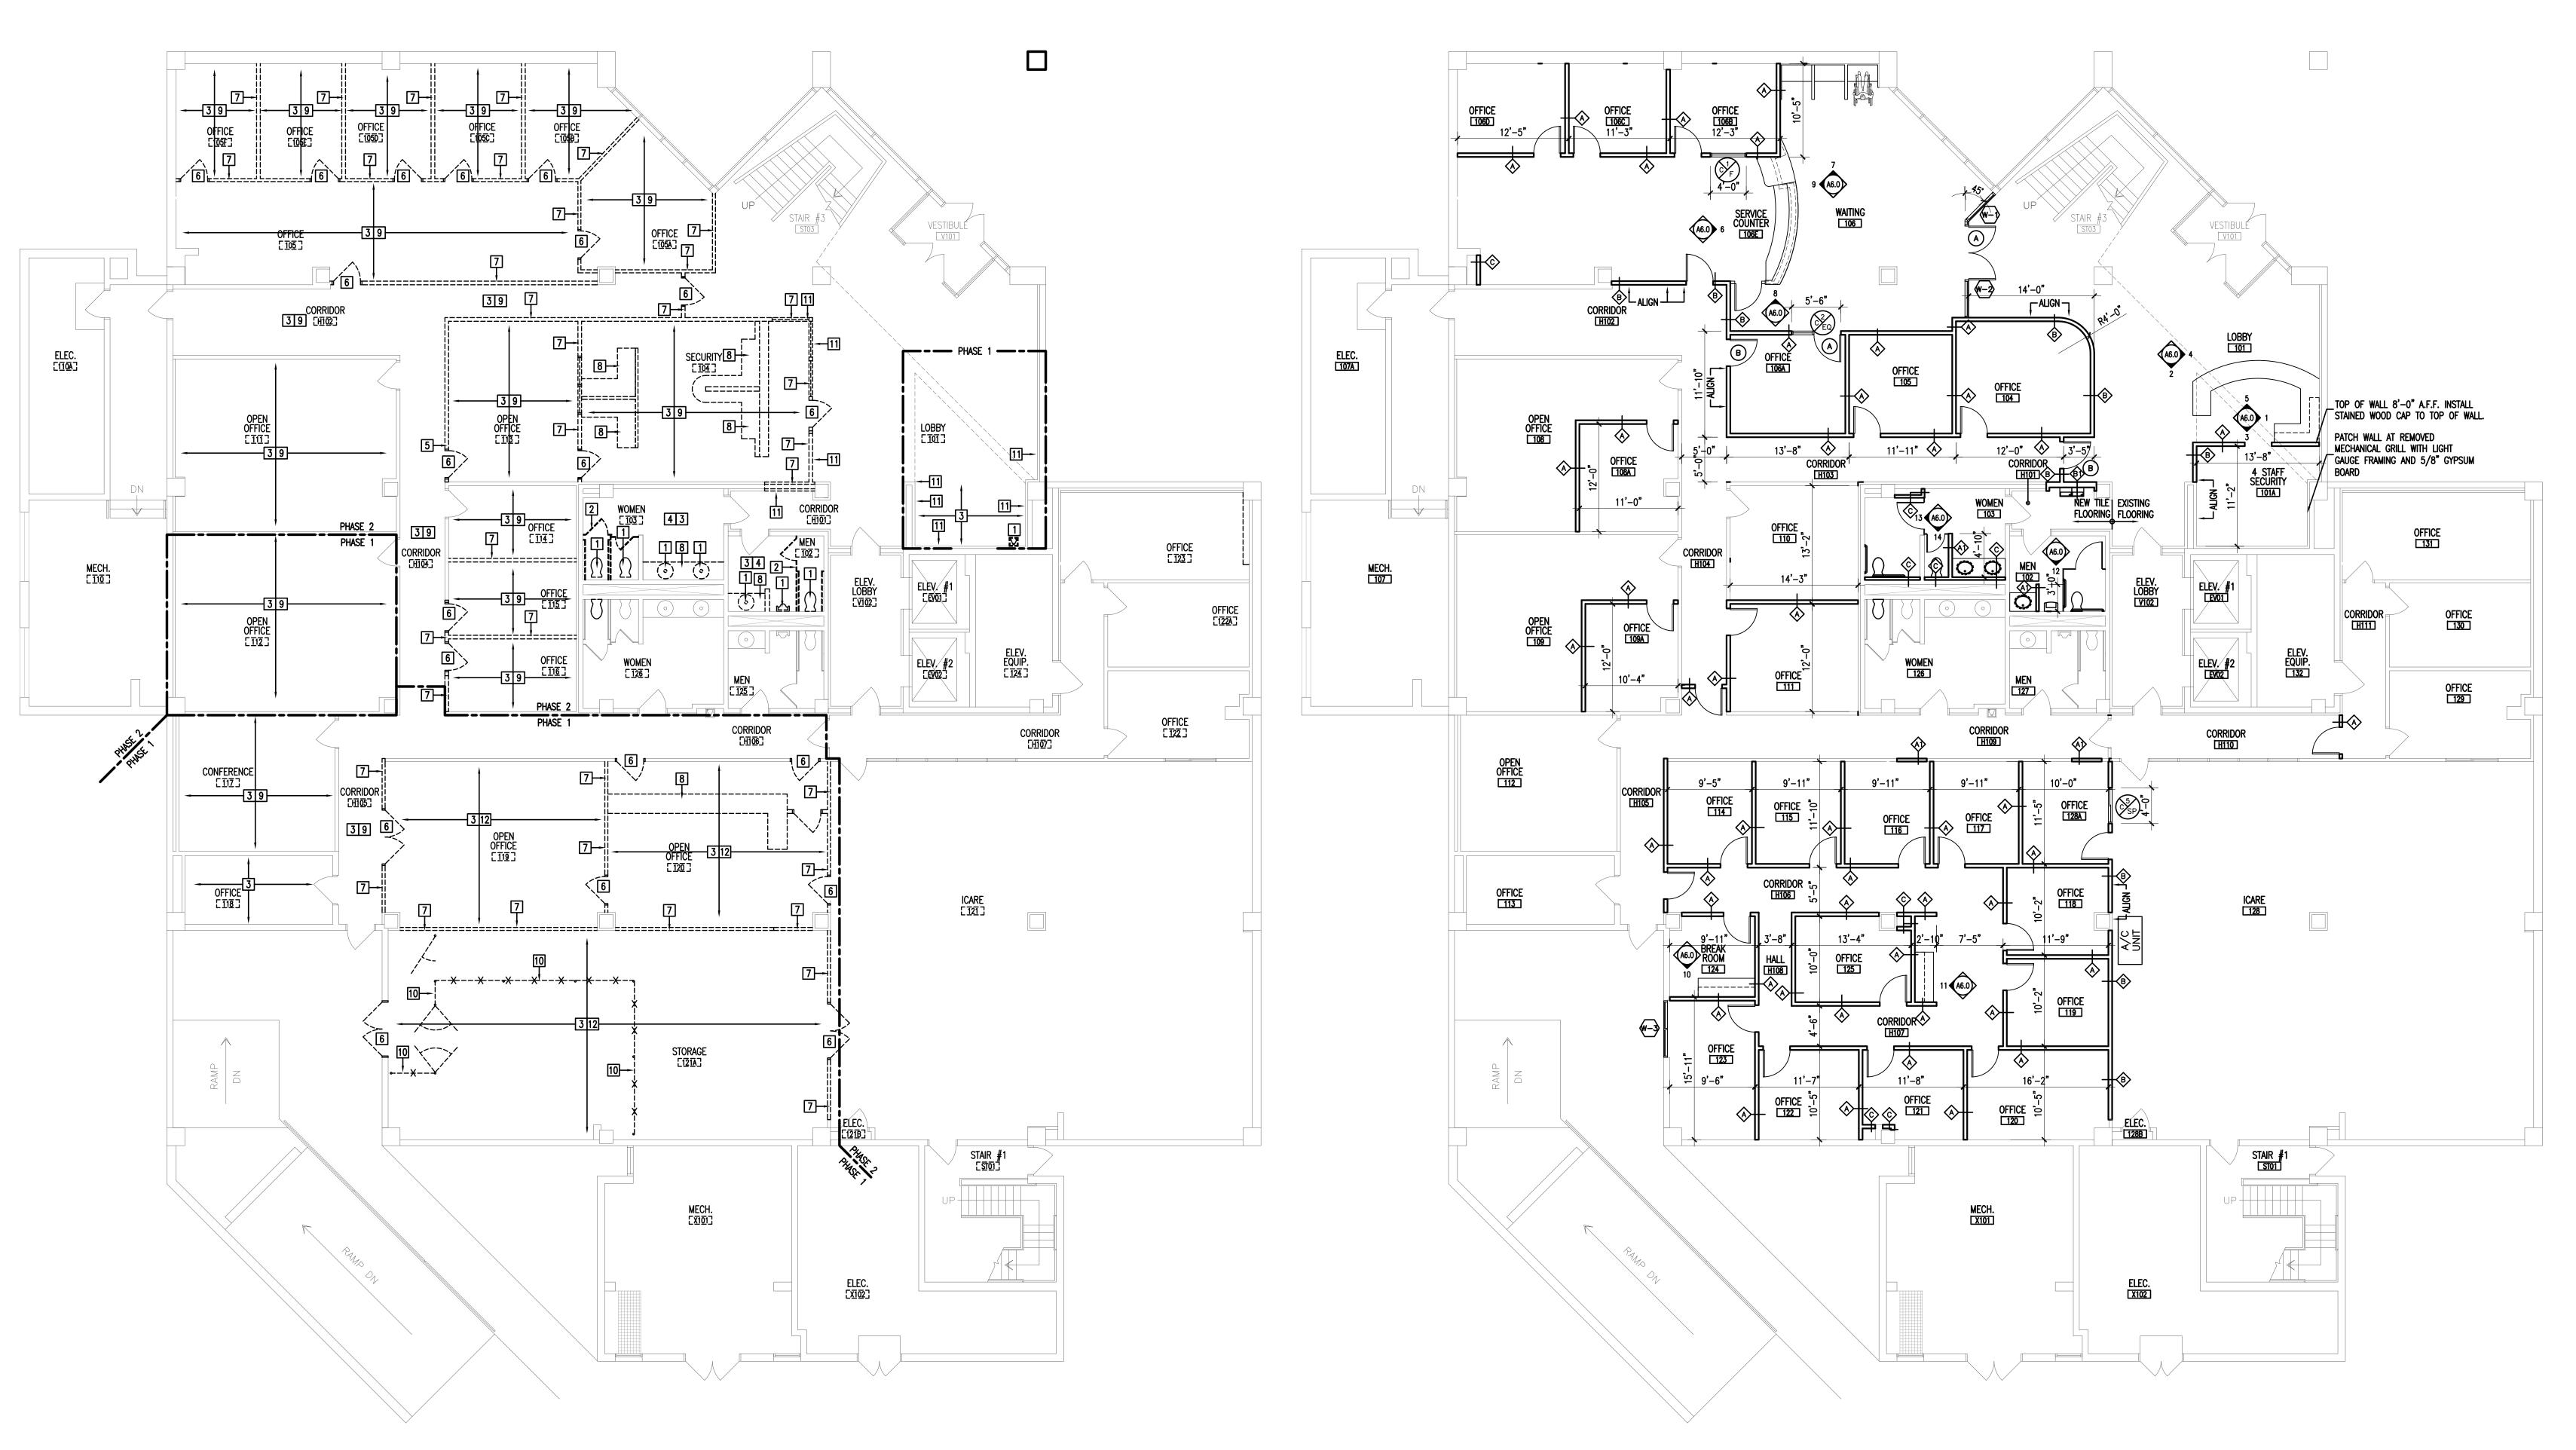

NOTIFY THE ARCHITECT IF DISCREPANCIES ARE DISCOVERED IN THE FIELD BETWEEN WHAT IS EXISTING AND WHAT IS SHOWN ON THE DRAWINGS. DO NOT PROCEED WITH DEMOLITION UNTIL THE DISCREPANCY IS RESOLVED BY THE

GENERAL DEMOLITION NOTES

- 2. WHERE A WALL IS INDICATED TO BE REMOVED, REMOVE ALL FINISHES FURRING AND TRIM UNLESS NOTED OTHERWISE.
- CONTRACTOR SHALL CLOSELY COORDINATE DEMOLITION WITH NEW CONSTRUCTION
- 4. NOT ALL DEMOLITION REQUIRED BY THE INSTALLATION OF NEW MECHANICAL AND ELECTRICAL SYSTEMS IS NECESSARILY INDICATED ON THE ARCHITECTURAL PLANS. COORDINATE ADDITIONAL DEMOLITION WORK ON ELECTRICAL, PLUMBING AND MECHANICAL SHEETS.
- WHENEVER DEMOLITION DAMAGES EXISTING CONSTRUCTION TO REMAIN, THE CONTRACTOR SHALL REPAIR THOSE SURFACES TO THE FINISH AND QUALITY OF ADJACENT SURFACES OF THE ORIGINAL CONDITION.
- 6. THE CONTRACTOR SHALL TAKE ALL NECESSARY PROVISIONS TO PROTECT THE EXISTING CONSTRUCTION TO REMAIN. CONSTRUCT DUST PROOF BARRIERS AS REQUIRED TO PREVENT THE PASSAGE OF DUST INTO OCCUPIED AREAS.
- CONTRACTOR SHALL REMOVE ALL FIRE EXTINGUISHERS AND MOUNTING BRACKETS AND STORE DURING THE RENOVATION. THE CONTRACTOR SHALL REINSTALL THE FIRE EXTINGUISHERS PRIOR TO OCCUPANCY.
- 8. CONTRACTOR IS RESPONSIBLE FOR ASSURING THAT FLOOR IS GROUND SMOOTH AT AREAS OF DEMOLITION AND MADE SMOOTH AND PREPPED FOR NEW FLOOR FINISH. THESE AREAS MAY OR MAY NOT BE IDENTIFIED ON THE DEMOLITION AND RENOVATION PLANS.

DEMOLITION NOTES

- 1 REMOVE EXISTING PLUMBING FIXTURES COMPLETE.
- REMOVE EXISTING TOILET PARTITIONS COMPLETE INCLUDING MOUNTING BRACKETS AND ALL ASSOCIATED HARDWARE.

 $\underbrace{1}_{1/8" = 1'-0"}
 FIRST FLOOR DEMOLITION PLAN$

- 3 REMOVE EXISTING CEILING COMPLETE INCLUDING HANGARS, SUPPORTS, ETC.
- REMOVE EXISTING CERAMIC TILE FLOOR. LEVEL CONCRETE FLOOR. PREPARE FLOOR SLAB TO RECEIVE NEW FINISH.
- REMOVE PORTION OF EXISTING WALL AS NECESSARY FOR THE INSTALLATION OF NEW DOOR AND FRAME.
- 6 REMOVE EXISTING DOOR, FRAME AND HARDWARE COMPLETE.
- 7 REMOVE EXISTING PARTITION COMPLETE.
- REMOVE EXISTING CASEWORK COMPLETE INCLUDING MOUNTING BRACKETS AND ALL ASSOCIATED HARDWARE. PATCH PLASTER WHERE SHELVING IS REMOVED.
- REMOVE EXISTING CARPET FLOOR COVERING. CONTRACTOR IS TO ENSURE ALL ACCESS FLOOR PANELS ARE PROPERLY SEATED AND PREPPED FOR INSTALLATION OF NEW OWNER FURNISHED AND INSTALLED CARPET TILE. IT IS THE CONTRACTOR'S RESPONSIBILITY TO ENSURE THAT ADHESIVES HAVE BEEN STRIPPED FROM THE ACCESS FLOOR PANELS. PREPARE SUBSTRATE TO RECEIVE NEW FLOOR
- REMOVE EXISTING CHAIN LINK FENCING COMPLETE. PATCH HOLES IN FLOOR AND PREPARE FLOOR SLAB FOR NEW FLOOR FINISH.
- REMOVE EXISTING CERAMIC TILE BASE AS REQUIRED FOR NEW CONSTRUCTION AND 111 WHERE NEW RUBBER BASE IS SCHEDULED IN THE FINISH SCHEDULE. SALVAGE BASE TO BE INSTALLED AS NEEDED ELSEWHERE IN THE LOBBY AREA.
- REMOVE EXISTING SHEET FLOORING PRODUCT FROM ACCESS FLOORING PANELS. PREPARE PANELS TO RECEIVE NEW FLOOR FINISH. REFER TO FINISH SCHEDULE.

PHASING NOTES

- DRAWINGS SHOW GENERAL INTENT OF DESIGN. CONTRACTOR SHALL COORDINATE CONSTRUCTION WITH PHASING. PHASING SHALL TAKE IN TO ACCOUNT ALL ASPECTS OF THE JOB INCLUDING HVAC, ELECTRICAL, NETWORK, PHONES, PLUMBING, ETC. BUILDING SHALL BE OCCUPIED AT ALL TIMES THROUGHOUT CONSTRUCTION. COORDINATE PHASING AND SHUTDOWNS WITH OWNER. OWNER SHALL BE PROVIDED WITH TWO WEEKS NOTICE PRIOR TO SHUTDOWNS. NO OCCUPIED FLOOR SHALL BE WITHOUT HVAC OR ELECTRICAL SERVICE DURING CONSTRUCTION OR DEMOLITION WORK.
- 2. PROVIDE TEMPORARY PROTECTION OF THE INGRESS/ EGRESS PATH WHILE WORK IS OCCURRING IN THE
- 3. THE FIRE ALARM WILL HAVE TO REMAIN ACTIVE THROUGHOUT CONSTRUCTION.
- 4. PHASE ONE SHALL INCLUDE DEMOLITION AND RENOVATION ACTIVITIES ASSOCIATED WITH THE FOLLOWING SPACES: OFFICE 117, 118, CORRIDORS H105, H106, OPEN OFFICE 119, 120, 112, STORAGE 121A AND THE NEW SECURITY AREA IN THE LOBBY. THE NEW DOOR H106 SHOULD ALSO BE INCLUDED IN THIS
- 5. PHASE TWO SHALL INCLUDE DEMOLITION AND RENOVATION ACTIVITIES ASSOCIATED WITH THE FOLLOWING SPACES: OFFICE 105, 105A, 105B, 105C, 105D, 105E, 105F, 114, 115, 116, OPEN OFFICE 111, 112, CORRIDOR H101, H102, H104, SECURITY 104, MEN 102 AND WOMEN 103.
- 6. OPEN OFFICE 112 WILL BE IN BOTH PHASES SINCE WORK WILL HAVE TO OCCUR ABOVE THE CEILING IN THAT OFFICE THROUGHOUT CONSTRUCTION.
- 7. A TEMPORARY SEPARATION SHALL BE INSTALL AS INDICATED ON THE DEMOLITION PLAN TO SEPARATE THE RETURN AIR PLENUM IN THE RENOVATED SPACE FROM AREAS UNDER CONSTRUCTION. THE CONTRACTOR IS TO ENSURE THAT RETURN FROM THE CONSTRUCTION ZONE IS SEPARATED FROM RETURN AIR FROM THE FINISHED SPACE.

2 FIRST FLOOR RENOVATION PLAN 1/8" = 1'-0"

GENERAL RENOVATION NOTES

- 1. REFER TO SHEET AO.O FOR GENERAL NOTES, SYMBOLS AND LEGENDS.
- 2. REFER TO SHEET A8.0 FOR PARTITION TYPES.
- 3. REFER TO SHEET A8.0 FOR DOOR SCHEDULE AND DETAILS.
- 4. REFER TO SHEET A8.0 FOR FINISH SCHEDULE.
- 5. THE BUILDING WILL BE PARTIALLY OCCUPIED THROUGHOUT CONSTRUCTION. THE CONTRACTOR IS RESPONSIBLE FOR PROTECTING ALL FINISHES, FURNISHINGS, EQUIPMENT AND ALL OTHER OWNER PROPERTY LEFT WITHIN BUILDING DURING CONSTRUCTION ACTIVITIES.
- 6. ALL AREAS TO RECEIVE NEW FLOORING SHALL BE INSTALLED ON STEEL ACCESS FLOOR PANELS EXCEPT THE FOLLOWING AREAS: MEN 102, WOMEN 103, SECURITY 101A, CORRIDOR H101, A PORTION OF CORRIDOR H103 AND A PORTION OF OFFICE 104.

ASSOCIATES, INC.

Design/Planning/Construction 1201 Main Street, Suite 2100 Columbia, S.C. 29201 tel. 803-256-0000

fax 803-255-7243

ALL RIGHTS RESERVED. THIS DRAWING AND THE DESIGN SHOWN THEREON ARE COPYRIGHTED AS PRESCRIBED BY THE LAWS OF THE UNITED STATES AND ARE THE PROPERTY OF GMK ASSOCIATES ARCHITECTURAL DIVISION. ANYONE DUPLICATING, REPRODUCING OR CAUSING TO BE REPRODUCED THE WHOLE OR PART OF THESE DRAWINGS OR THE DESIGN THEREON WITHOUT PERMISSION OF THE ARCHITECT WILL BE SUBJECT TO LEGAL ACTION.

consultants

USC CAMPUS PLANNING AND CONSTRUCTION 743 GREENE STREET COLUMBIA, SOUTH CAROLINA


BURSAR - REGISTRAR OFFICE EXPANSION - UTS RENOVATIONS OSE # H27-Z052-A


project number 08040.04

seals/signature

CONSTRUCTION DOCUMENTS

JULY 23, 2013

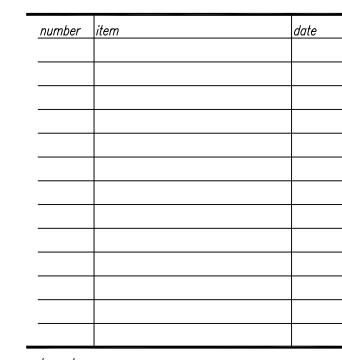


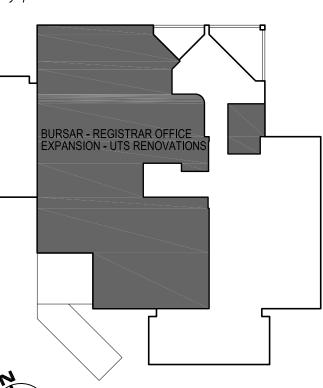

FIRST FLOOR DEMOLITION AND RENOVATION PLANS

sheet number

checked by JKS

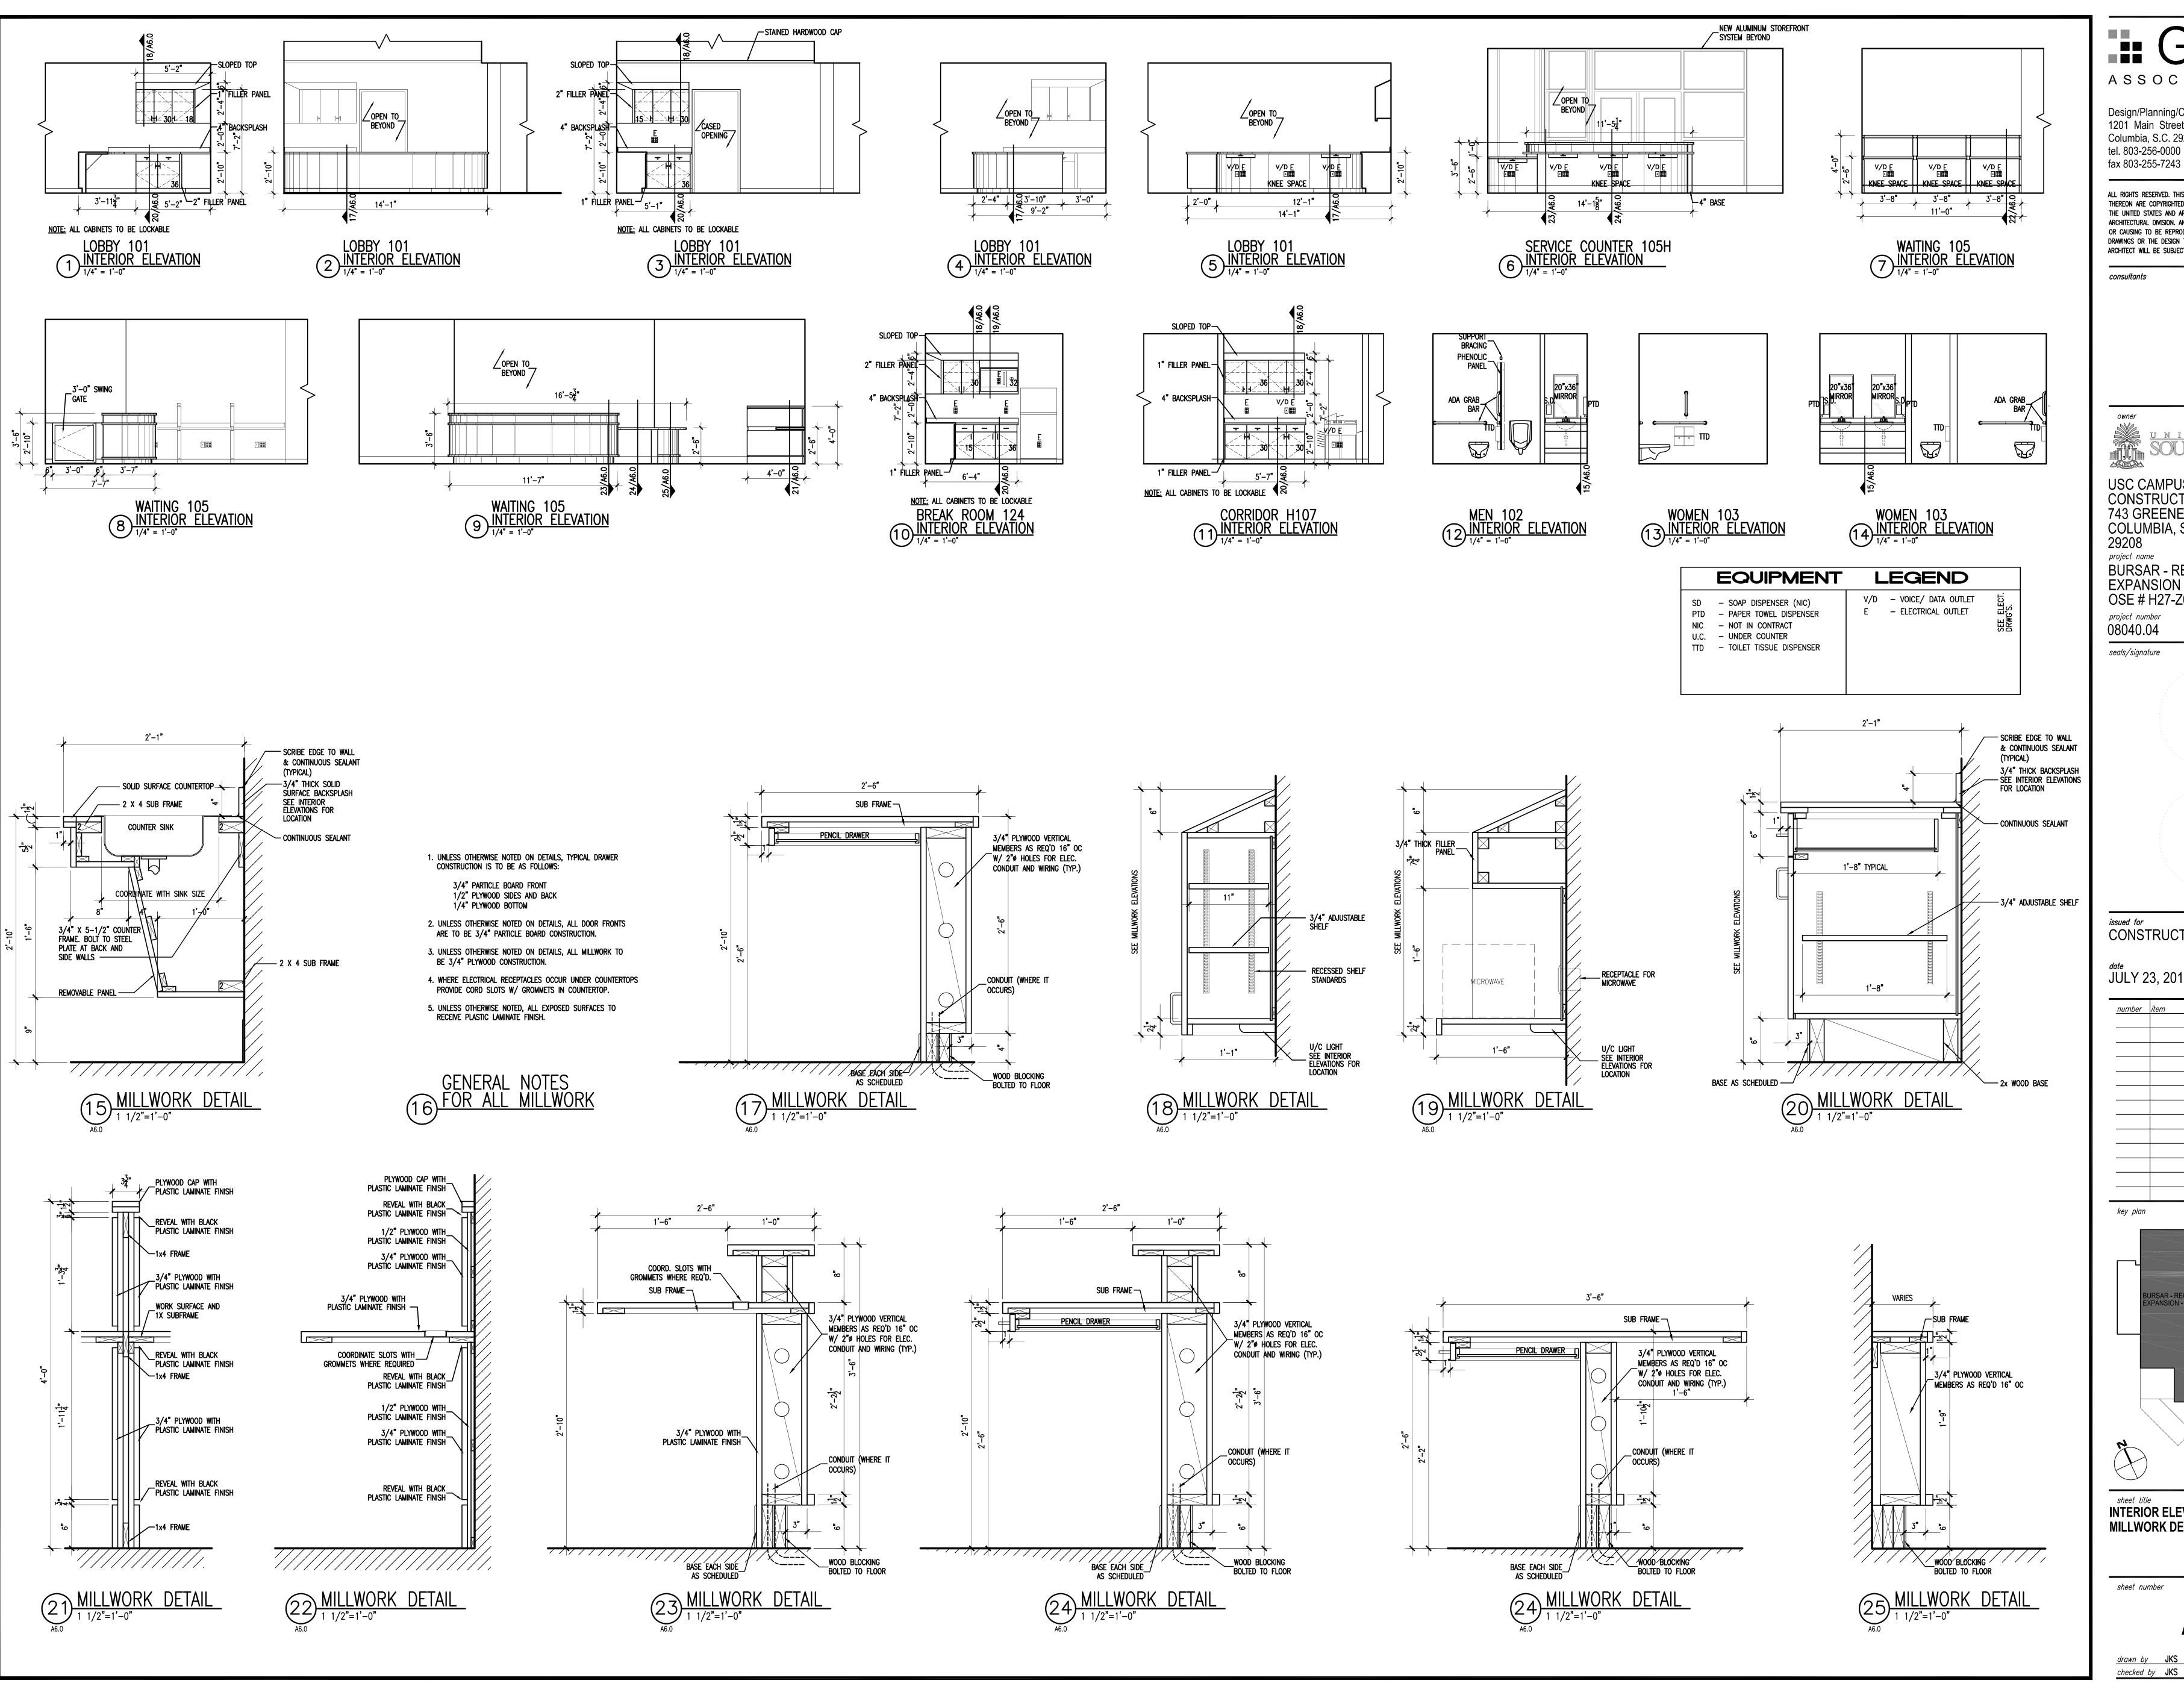

ASSOCIATES, INC.

Design/Planning/Construction 1201 Main Street, Suite 2100 Columbia, S.C. 29201 tel. 803-256-0000 fax 803-255-7243

ALL RIGHTS RESERVED. THIS DRAWING AND THE DESIGN SHOWN THEREON ARE COPYRIGHTED AS PRESCRIBED BY THE LAWS OF THE UNITED STATES AND ARE THE PROPERTY OF GMK ASSOCIATES ARCHITECTURAL DIVISION. ANYONE DUPLICATING, REPRODUCING OR CAUSING TO BE REPRODUCED THE WHOLE OR PART OF THESE DRAWINGS OR THE DESIGN THEREON WITHOUT PERMISSION OF THE ARCHITECT WILL BE SUBJECT TO LEGAL ACTION.

consultants

USC CAMPUS PLANNING AND CONSTRUCTION 743 GREENE STREET COLUMBIA, SOUTH CAROLINA 29208 project name


BURSAR - REGISTRAR OFFICE EXPANSION - UTS RENOVATIONS OSE # H27-Z052-A project number


08040.04

seals/signature

CONSTRUCTION DOCUMENTS

JULY 23, 2013

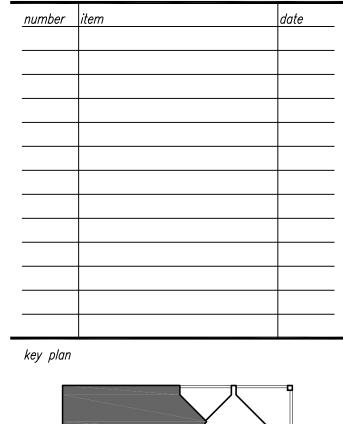


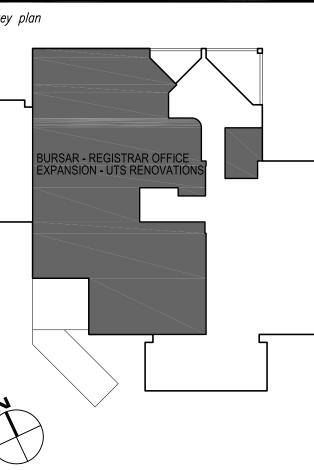

sheet title **INTERIOR ELEVATIONS AND MILLWORK DETAILS**

sheet number

A6.0

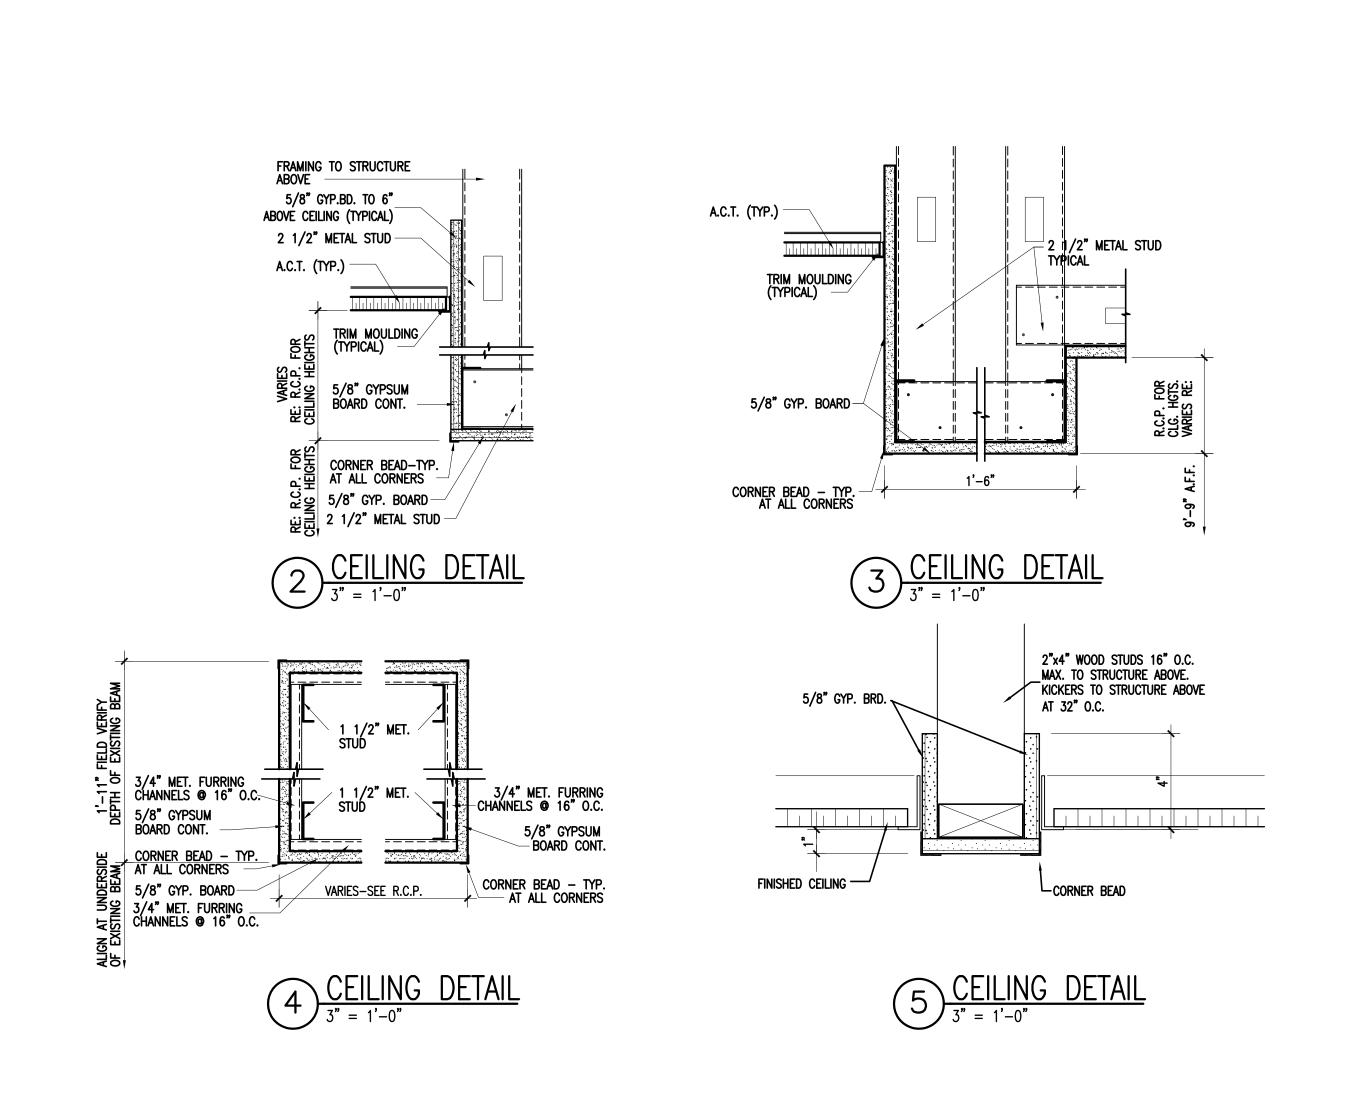



ASSOCIATES, IN C.

Design/Planning/Construction 1201 Main Street, Suite 2100 Columbia, S.C. 29201 tel. 803-256-0000 fax 803-255-7243

ALL RIGHTS RESERVED. THIS DRAWING AND THE DESIGN SHOWN THEREON ARE COPYRIGHTED AS PRESCRIBED BY THE LAWS OF THE UNITED STATES AND ARE THE PROPERTY OF GMK ASSOCIATES ARCHITECTURAL DIVISION. ANYONE DUPLICATING, REPRODUCING OR CAUSING TO BE REPRODUCED THE WHOLE OR PART OF THESE DRAWINGS OR THE DESIGN THEREON WITHOUT PERMISSION OF THE ARCHITECT WILL BE SUBJECT TO LEGAL ACTION.

consultants

owner

UNIVERSITY OF

SOUTH AROLINA

USC CAMPUS PLANNING AND CONSTRUCTION 743 GREENE STREET COLUMBIA, SOUTH CAROLINA 29208

project name

BURSAR - REGISTRAR OFFICE EXPANSION - UTS RENOVATIONS OSE # H27-Z052-A

project number 08040.04


seals/signature

issued for CONSTRUCTION DOCUMENTS

^{date} JULY 23, 2013

number	item	date

t and a factor

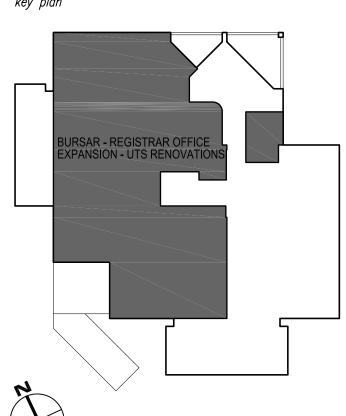


sheet title
FIRST FLOOR REFLECTED
CEILING PLAN

sheet numb

A7.1

drawn by JKS checked by TMW

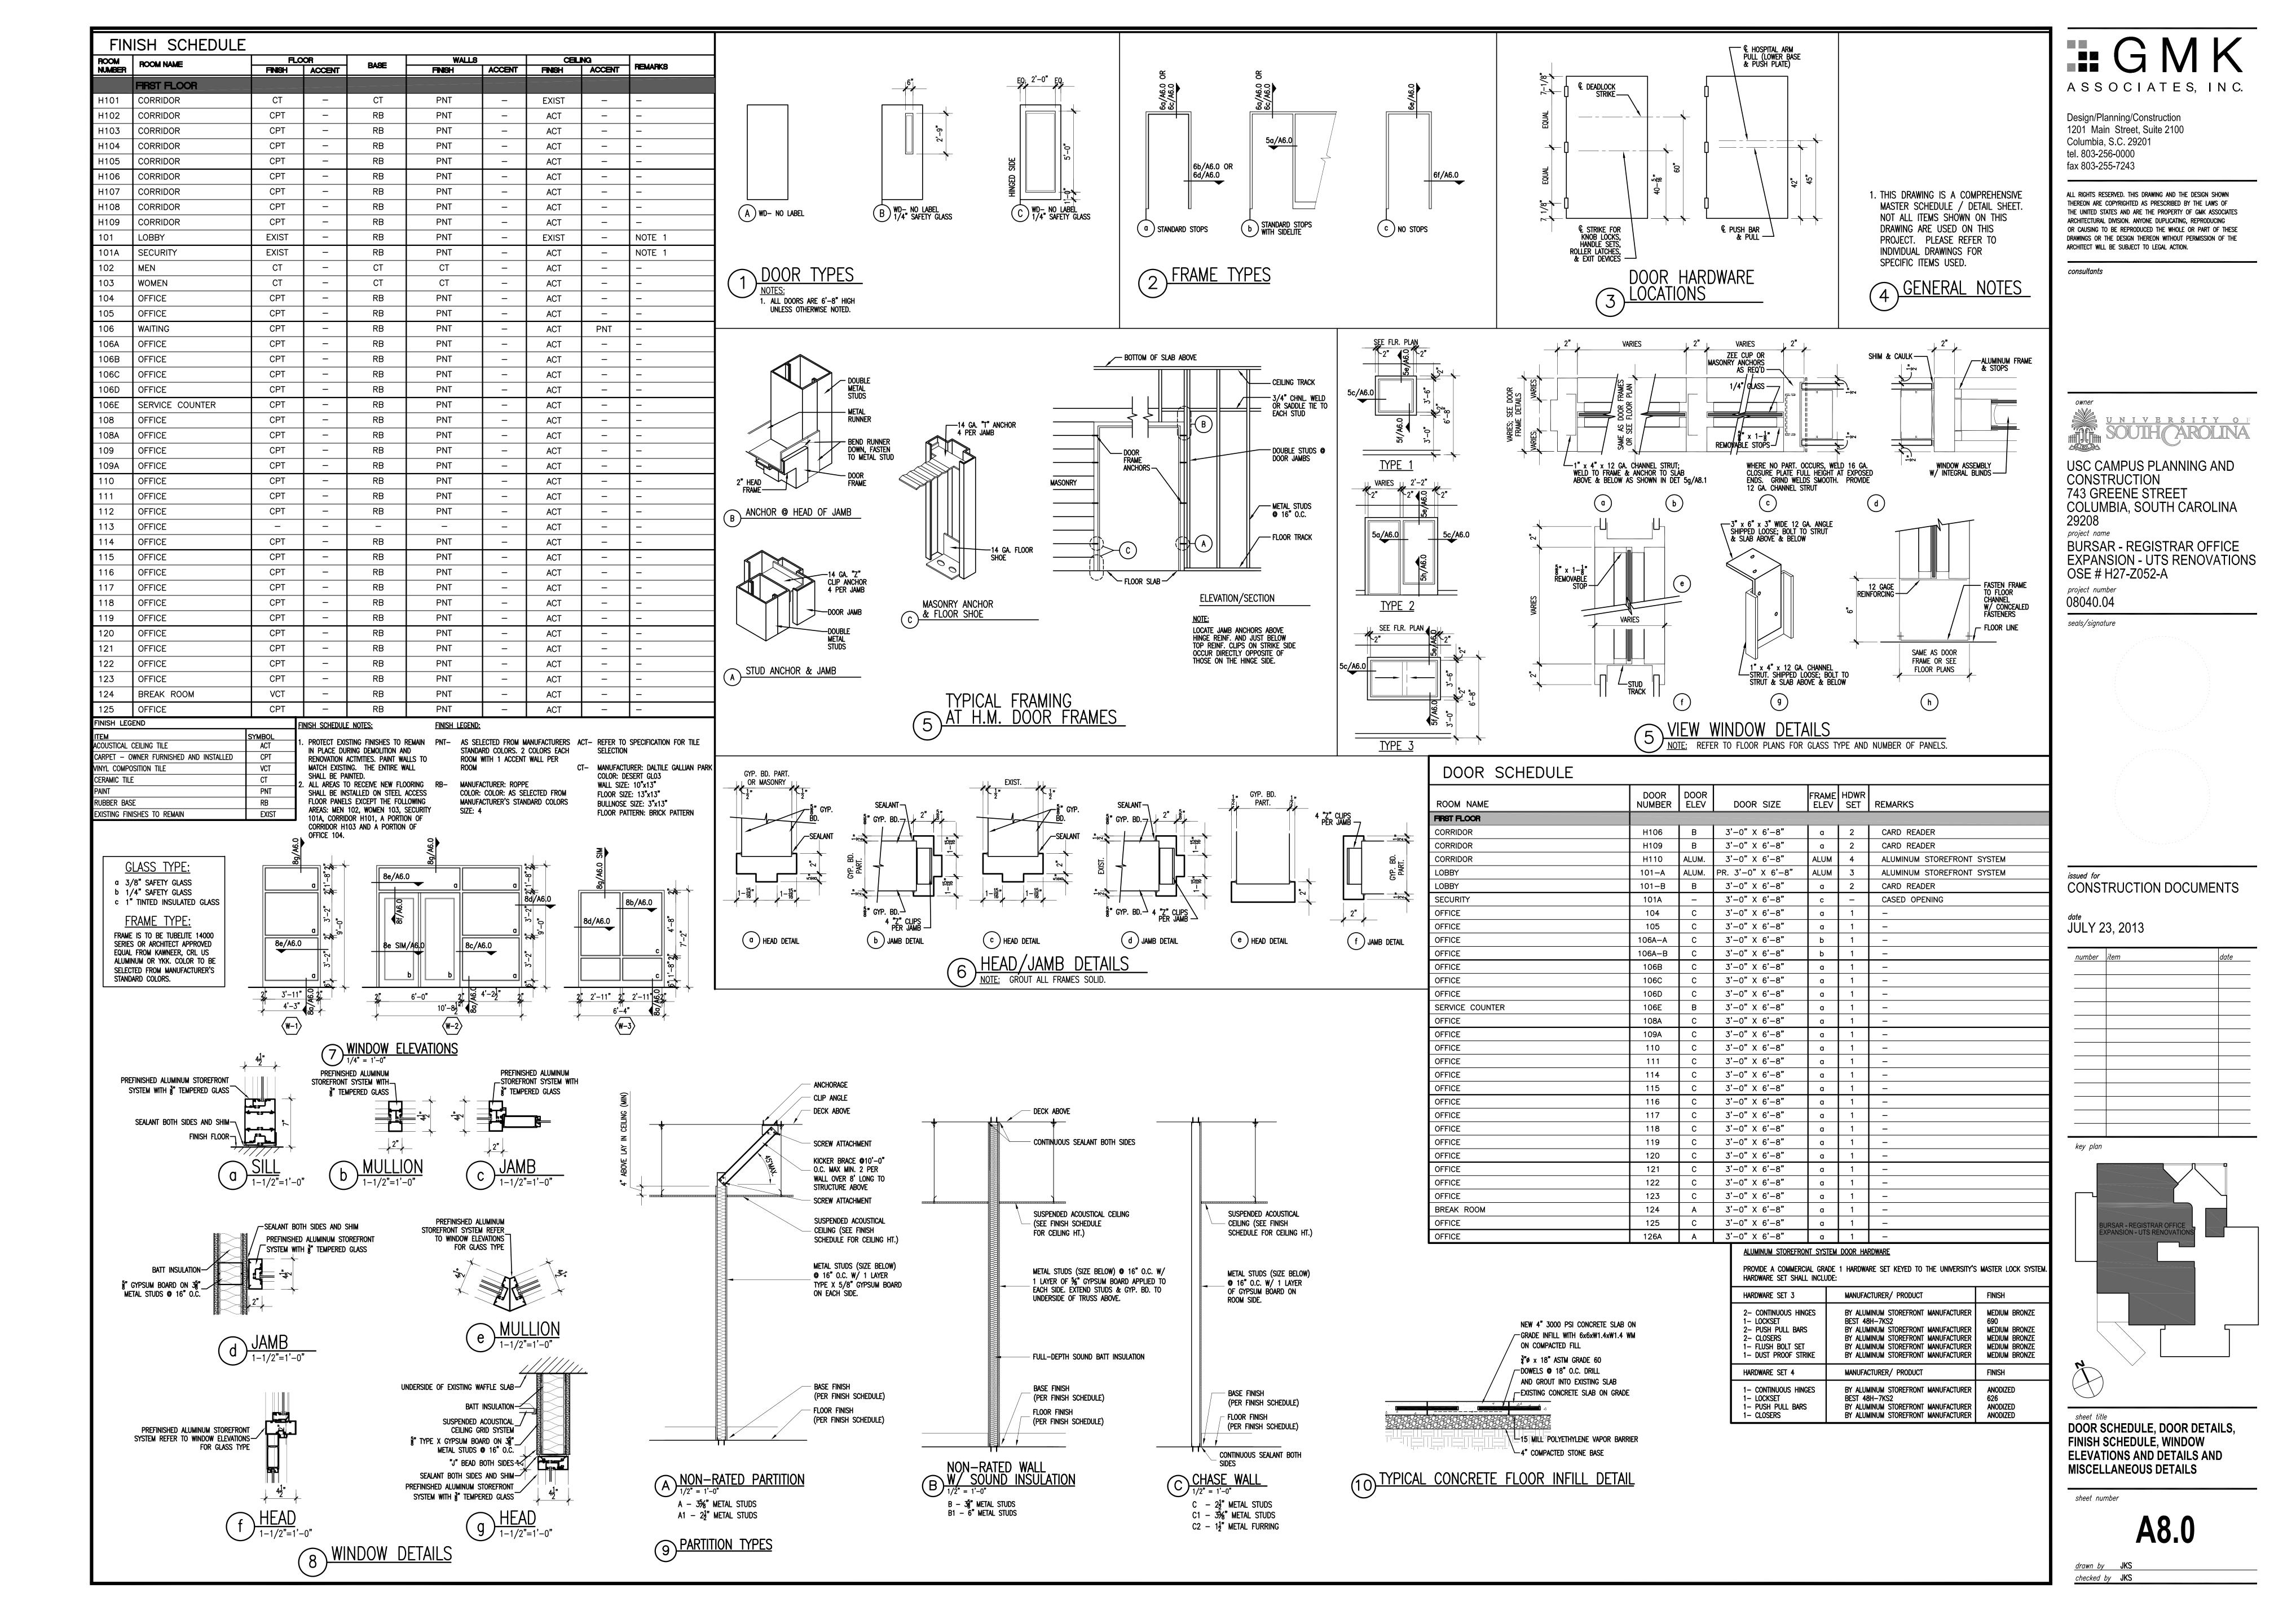

			FIXTURE SCHEDULE					
=::-:	SIMILAR TO				FIXTUR	CONNEC	TION	
FIXTURE	MODEL	PICTURE	FIXTURE & FITTINGS INFORMATION	S	٧	CW	HW	OTHER
	KOHLER K-4330		SIPHON JET, ELONGATED BOWL, VITREOUS CHINA, 1.6 GAL FLUSH VALVE. BENEKE 523-SS WHITE SOLID PLASTIC ELONGATED OPEN FRONT, STAINLESS STEEL POST, SELF-SUSTAINING CHECK HINGES. SLOAN ROYAL 111 WITH SCREW DRIVER STOPS. J.R. SMITH SERIES 400 WALL CARRIER.		2"	1"		
WC-1	Ġ							
	KOHLER K-4330		SIPHON JET, ELONGATED BOWL, VITREOUS CHINA, 1.6 GAL FLUSH VALVE. BENEKE 523-SS WHITE SOLID PLASTIC ELONGATED OPEN FRONT, STAINLESS STEEL POST, SELF-SUSTAINING CHECK HINGES. SLOAN ROYAL 111 WITH SCREW DRIVER STOPS. J.R. SMITH SERIES 400 WALL CARRIER. RIM 16-1/2" AFF.		2"	1"		
WC-1A	Ė							
	KOHLER K-4960		SIPHON JET, VITREOUS CHINA, 1.0 GAL FLUSH VALVE. SLOAN REGAL 186 WITH SCREW STOPS. JR SMITH		1-1/4"	3/4"		
U-1A	£		637 BLOCK BASE. WALL MOUNT, 17" AFF TO RIM.	NOTE:				
	KOHLER K-2196		20"x17" VITREOUS CHINA, OVAL, COUNTER MOUNT AS SHOWN ON ARCH DWGS. DELTA 501 WASHERLESS	1-1/4"	1-1/4"	1/2"	1/2"	
L-1A	E		SINGLE LEVER WITH AERATOR & 2 GPM FLOW CONTROL. McGUIRE 165LK SUPPLY WITH LOOSE KEY STOPS. McGUIRE DRAIN 155WC WITH OPEN GRID STRAINER & OFFSET TAILPIECE. McGUIRE TRAP 8872 WITH CO PLUG.	NOTE: ALL EXPOSED PIPING BENEATH WITH HANDI—LAV GUARD MODEL 102.				
	ELKAY EZSTL8C ELECTRIC WATER COOLER SS FINISH. 8.0 GPH 50' WATER AT 90' AMBIENT. WALL MOUNT 31" AFF TO			1-1/4" NOTE:	1-1/4"	1/2"		
EWC-1A	£		RIM. McGUIRE TRAP 8872 WITH CO PLUG. JR SMITH 824 BLOCK BASE CARRIER.					

PLUMBING GENERAL NOTES

- 1. VERIFY EXACT LOCATION OF ALL PLUMBING FIXTURES IN OR ATTACHED TO CASEWORK WITH THE ARCHITECT AND THE MILLWORK SHOP DRAWINGS. COORDINATE PRIOR TO INSTALLATION.
- 2. CONFIRM OR VERIFY EXACT LOCATION AND ACTUAL INVERT OF SANITARY LINES PRIOR TO INSTALLATION.
- 3. LOCATE SHUT-OFF VALVE ABOVE CEILING AND IN LOCATIONS ACCESSIBLE FOR SERVICE. LOCATION SHALL COMPLY WITH THE REQUIREMENTS OF ALL CODES REFERENCED HEREIN.
- 4. ALL SANITARY DRAINAGE PIPING 3" AND LARGER SHALL SLOPE 1/8" PER FOOT UNLESS NOTED OTHERWISE. ALL SANITARY DRAINAGE PIPING 2-1/2" AND SMALLER SHALL SLOPE 1/4" PER FOOT UNLESS NOTED OTHERWISE.
- 5. CONTRACTOR SHALL REFERENCE DIVISION 15 OF THE SPECIFICATIONS AND EQUIPMENT SCHEDULE FOR PLUMBING FIXTURES, EQUIPMENT AND MATERIALS AND INSTALLATION PROCEDURES.
- 6. ALL CLEANOUTS AND FLOOR DRAINS SHALL BE INSTALLED PLUMB AND LEVEL WITH FINISHED FLOOR ELEVATION FOR SLAB INSTALLATION. REFER TO STRUCTURAL DRAWINGS FOR SLAB ELEVATIONS AND SLOPES.
- CONTRACTOR SHALL PROVIDE HANGERS AND SUPPORTS FOR SEISMIC RESTRAINT PER THE 2009 SOUTH CAROLINA PLUMBING CODE. (IPC 2009)
- 8. ALL DRAINAGE PIPING AND PRESSURE SYSTEM PIPING SHALL BE RUN AS HIGH AS POSSIBLE TO BOTTOM OF STRUCTURE, UNLESS NOTED OTHERWISE. COORDINATE PIPE ROUTING WITH ALL OTHER TRADES.
- 9. IT SHALL BE THE RESPONSIBILITY OF THE CONTRACTOR TO VERIFY THAT ITEMS TO BE FURNISHED FIT THE SPACE AVAILABLE.
- 10. THESE DRAWINGS ARE SCHEMATIC IN NATURE AND DO NOT SHOW EXACT LOCATIONS OF FIXTURES AND EQUIPMENT. ALL OFFSETS AND FITTINGS FOR COMPLETE INSTALLATION MAY NOT BE DEFINED ON THE DRAWINGS. CONTRACTOR SHALL BE RESPONSIBLE FOR VERIFYING EXACT DIMENSIONS AT THE BUILDING AND ANY NECESSARY CHANGES MADE IN ACCORDANCE WITH STRUCTURAL CONDITIONS, EQUIPMENT TO BE INSTALLED AND COORDINATION WITH OTHER SYSTEMS. IF CONFLICTS CANNOT BE RESOLVED THEY SHALL BE BROUGHT TO THE IMMEDIATE ATTENTION OF THE ENGINEER.
- 11. CONTRACTOR SHALL SECURE ALL PERMITS, INSPECTIONS, LICENSES AND TESTS REQUIRED FOR THIS WORK AND PAY ALL FEES IN CONNECTION
- 12. ALL MATERIALS SHALL BEAR THE MANUFACTURER'S NAME, TRADE NAME AND BE U.L. LABELED IF REQUIRED. UNLESS SPECIFICALLY INDICATED OTHERWISE, ALL EQUIPMENT AND MATERIALS SHALL BE INSTALLED IN ACCORDANCE WITH THE RECOMMENDATIONS OF THE MANUFACTURER. ALL EQUIPMENT OF A SIMILAR TYPE SHALL BE OF THE SAME MANUFACTURER.
- 13. CONTRACTOR SHALL PROVIDE AND LOCATE CORE DRILLS IF REQUIRED BEFORE THE WALLS ARE BUILT AND SHALL BE RESPONSIBLE FOR THE COST OF CORE DRILLING AND PATCHING REQUIRED FOR PIPES WHERE THEY PASS THROUGH FINISHED SLAB.
- 14. THE ENGINEER SHALL NOT BE RESPONSIBLE FOR THE MEANS, METHODS, TECHNIQUES, SEQUENCES OR PROCEDURES OF CONSTRUCTION SELECTED BY THE CONTRACTOR OR OF THE SAFETY PRECAUTIONS AND PROGRAMS INCIDENTAL TO THE WORK OF THE CONTRACTOR. THE ENGINEER SHALL NOT BE RESPONSIBLE FOR THE FAILURE OF THE CONTRACTOR TO PERFORM THE CONSTRUCTION WORK IN ACCORDANCE WITH THE DRAWINGS.
- 15. ALL WALL HUNG FIXTURES AND FLOOR MOUNTED MOP SINKS SHALL BE SEALED BETWEEN WALL AND FIXTURES WITH WHITE SILICONE CAULKING.
- 16. ALL COUNTER MOUNTED FIXTURE RIMS SHALL BE SEALED WITH SILICONE CAULKING.
- 17. LOCATE FLOOR CLEANOUTS PAST LIMITS OF THE CASEWORK.
- 18. IT IS THE INTENT AND MEANING OF THE DRAWINGS TO PROVIDE COMPLETE AND OPERABLE PLUMBING AND DRAINAGE SYSTEMS.
- 19. ALL PLUMBING LINE SIZE REDUCTIONS SHALL BE MADE WITH REDUCERS AND/OR REDUCING FITTINGS.
- 20. DUE TO THE LIMITED SPACE ABOVE THE CEILING, AND THE AMOUNT OF DUCT WORK AND PIPING COORDINATION WITH OTHER DISCIPLINES IS MANDATORY.
- 21. ALL BALL VALVES SHALL BE APOLLO FULL PORT TYPE.
- 22. THE OWNER SHALL HAVE FIRST REFUSAL OF EQUIPMENT AND FIXTURES BEING REMOVED FROM THIS PROJECT.

WATER-HAMMER ARRESTER SCHEDULE								
PDI UNITS	А	В	С	D	E	F		
FIXTURE UNITS	1-11	12-32	33-60	61–113	114-154	155-330		

ABV	Above	N	Nitrogen
AD	Access Door	NIC	Not in Contract
AFF	Above Finished Floor	NO	Nitrous Oxide
BFP	Backflow Preventer	NPT	National Pipe Thread
CI	Cast Iron	NTS	Not To Scale
COL	Column Line	OFST	Over Flow Storm Drain
CONN	Connection	OX	Oxygen
CW	Cold Water	P-#	Pump – No.
DI	Delonized Water	PRV	Pressure Reducing Valve
DN	Down	PSI	Pounds Per Square Inc
ELEV	Elevation	RD	Roof Drain
ET	Expansion Tank	SH-#	Shower
EWC-#	Electric Water Cooler	SK-#	Sink
FD "	Floor Drain	SS "	Stainless Steel
FL	Floor	ST	Storm Drain
FS	Floor Sink	STD	Standard
FT	Feet	TEMP	Temperature
GPH	Gallons Per Hour	TOS	Top of Steel
GPM	Gallons Per Minute	TYP	Typical
HW	Hot Water	U -#	Urinal
HWR	Hot Water Return	VAC	Vacuum
ΙE	Invert Elevation	VB	Vacuum Breaker
L-#	Lavatory	٧	Sanitary Vent
MA "	Medical Air	VTR	Vent Thru Roof
MAX	Maximum	W	Sanitary Waste
MIN	Minimum	WB-#	Wall Box
MPT	Male Pipe Thread	wc-#	Water Closet
MSB-#	Mop Sink Basin	wts "	Water Tight Sleeve
N/A	Not Applicable		,

_		
	PLU	MBING LEGEND
	SYMBOL	DESCRIPTION
		COLD WATER LINE — ABOVE GROUND (CW)
		HOT WATER LINE (HW)
		SANITARY WASTE — ABOVE GROUND (S/W)
		SANITARY VENT LINE (V)
	FCO 🛞	FLOOR CLEANOUT
	co —	WALL/INLINE CLEANOUT
	FD 🔘	FLOOR DRAIN
		BALL VALVE
		PIPE DOWN OR DROP (DN OR DROP)
	<u> </u>	PIPE UP
		PIPE BREAK OR CONTINUATION
	\(\rightarrow \)	CONNECT TO EXISTING
	///////	AREA TO BE DEMOLISHED
	wco —]	WALL CLEANOUT

FI	XTURE	SIZE	SC	CHEDU	LE
MARK	WASTE	VENT		CW	нм
WC	3"	2"	十	1"	
L	2"	1 1/2"		1/2"	1/2
U	2"	1 1/2"		3/4"	
EWC	1-1/2"	1 1/4"		1/2"	

NOTE: USE THESE SIZES FOR FIXTURE CONNECTIONS UNLESS OTHERWISE NOTED

ASSOCIATES, INC.

Design/Planning/Construction 1201 Main Street, Suite 2100 Columbia, S.C. 29201 tel. 803-256-0000 fax 803-255-7243

ALL RIGHTS RESERVED. THIS DRAWING AND THE DESIGN SHOWN THEREON ARE COPYRIGHTED AS PRESCRIBED BY THE LAWS OF THE UNITED STATES AND ARE THE PROPERTY OF GMK ASSOCIATES ARCHITECTURAL DIVISION. ANYONE DUPLICATING, REPRODUCING OR CAUSING TO BE REPRODUCED THE WHOLE OR PART OF THESE DRAWINGS OR THE DESIGN THEREON WITHOUT PERMISSION OF THE ARCHITECT WILL BE SUBJECT TO LEGAL ACTION.


consultants



USC CAMPUS PLANNING AND CONSTRUCTION
743 GREENE STREET
COLUMBIA, SOUTH CAROLINA
29208
project name


BURSAR - REGISTRAR OFFICE EXPANSION - UTS RENOVATIONS OSE # H27-Z052-A

08040.04

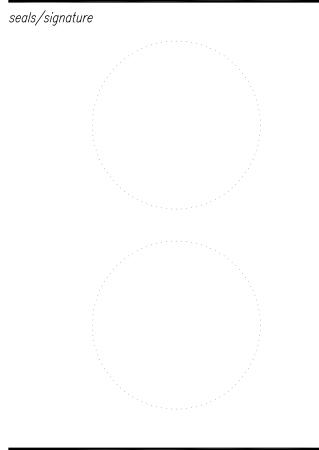

CONSTRUCTION DOCUMENTS

^{date} JULY 23, 2013

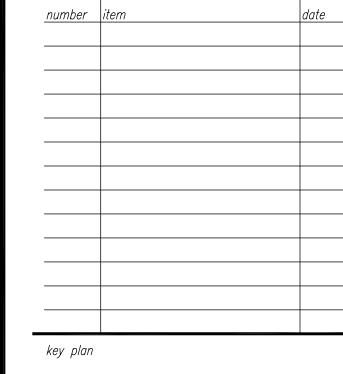

BURSAR - REGISTRAR OFFICE EXPANSION - UTS RENOVATIONS

sheet title

LEGEND, SCHEDULES, ABBREVIATIONS NOTES AND DETAILS

sheet number

P0.0

drawn by RLW checked by JWB



1) FIRST FLOOR PLUMBING DEMOLITION PLAN 1/8"=1'-0"

DEMOLITION KEYNOTES:

- DEMOLISH EXISTING WATER CLOSET, SANITARY PIPING AND CW PIPING BACK TO MAIN IN CHASE CAP TEMPORARY FOR FUTURE CONNECTION. REMOVE WATER CLOSET CARRIERS AND CAP TEMPORARY VENT PIPING IN CHASE ABOVE FOR FUTURE CONNECTION TO NEW CARRIERS. SEE NOTE #6 INDICATING WHERE CARRIER ARE TO REMAIN IN SERVICE.
- SEE NOTE #6 INDICATING WHERE CARRIER ARE TO REMAIN IN SERVICE.

 2 DEMOLISH EXISTING LAVATORY AND WASTE PIPING BACK TO CAPPED LINE.
- DEMOLISH EXISTING WATER COOLER. CAP WATER PIPING AND VENT PIPING IN WALL OR ABOVE CEILING. CAP WASTE PIPING IN WALL OR BELOW FINISH FLOOR.

 DEMOLISH EXISTING WATER CLOSET. REMOVE WASTE PIPING FROM
- 4 DEMOLISH EXISTING WATER CLOSET. REMOVE WASTE PIPING FROM CARRIER AND CAP THIS SIDE OF CARRIER. REMOVE CW PIPING AND CAP IN CHASE.
- (5) DEMOLISH EXISTING URINAL AND SINGLE CARRIER IN WALL. CAP WASTE AND CW PIPING IN CHASE.
- THIS EXISTING CARRIER TO REMAIN IN SERVICE. MODIFY TO SUIT NEW CONFIGURATION.
- 7 COORDINATE ALL PLUMBING SHUT-DOWNS WITH USC ENGINEERING DEPARTMENT.
- B DEMOLISH AND REMOVE EXISTING WCO. PROVIDE TEMPORARY PIPE CAP.

checked by **JWB**

sheet number

DEMOLITION PLAN

PLUMBING FIRST FLOOR

drawn by RLW

Design/Planning/Construction
1201 Main Street, Suite 2100
Columbia, S.C. 29201
tel. 803-256-0000
fax 803-255-7243

ASSOCIATES, INC.

ALL RIGHTS RESERVED. THIS DRAWING AND THE DESIGN SHOWN THEREON ARE COPYRIGHTED AS PRESCRIBED BY THE LAWS OF THE UNITED STATES AND ARE THE PROPERTY OF GMK ASSOCIATES ARCHITECTURAL DIVISION. ANYONE DUPLICATING, REPRODUCING OR CAUSING TO BE REPRODUCED THE WHOLE OR PART OF THESE DRAWINGS OR THE DESIGN THEREON WITHOUT PERMISSION OF THE ARCHITECT WILL BE SUBJECT TO LEGAL ACTION.

consultants

owner

UNIVERSITY OF

SOUTH CAROLINA

USC CAMPUS PLANNING AND CONSTRUCTION 743 GREENE STREET COLUMBIA, SOUTH CAROLINA 29208

project name


BURSAR - REGISTRAR OFFICE EXPANSION - UTS RENOVATIONS OSE # H27-Z052-A

08040.04



issued for CONSTRUCTION DOCUMENTS

^{date} JULY 23, 2013

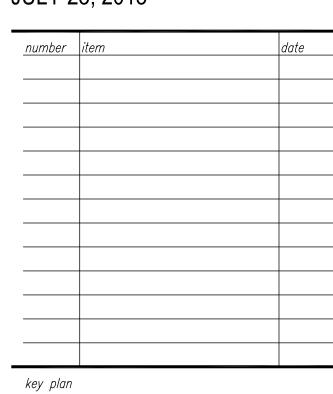

BURSAR - REGISTRAR OFFICE EXPANSION - UTS RENOVATIONS



(6) CONNECT 2" WASTE LINE TO 5" SANITARY LINE BELOW SLAB.

(8) CONNECT S.A. TO EXISTING CW MAIN IN CHASE. FIELD VERIFY LOCATION.

PDI UNITS

FIXTURE UNITS

1-11 12-32

33-60 61-113 114-154 155-330

 \bigcirc connect 1/2" cw line to cw main in chase.

(9) INSTALL NEW WALL CLEAN OUT.

ASSOCIATES, INC.

Design/Planning/Construction 1201 Main Street, Suite 2100 Columbia, S.C. 29201 tel. 803-256-0000 fax 803-255-7243


ALL RIGHTS RESERVED. THIS DRAWING AND THE DESIGN SHOWN THEREON ARE COPYRIGHTED AS PRESCRIBED BY THE LAWS OF THE UNITED STATES AND ARE THE PROPERTY OF GMK ASSOCIATES ARCHITECTURAL DIVISION. ANYONE DUPLICATING, REPRODUCING OR CAUSING TO BE REPRODUCED THE WHOLE OR PART OF THESE DRAWINGS OR THE DESIGN THEREON WITHOUT PERMISSION OF THE ARCHITECT WILL BE SUBJECT TO LEGAL ACTION.

consultants

USC CAMPUS PLANNING AND CONSTRUCTION 743 GREENE STREET COLUMBIA, SOUTH CAROLINA 29208 project name


BURSAR - REGISTRAR OFFICE EXPANSION - UTS RENOVATIONS OSE # H27-Z052-A


08040.04

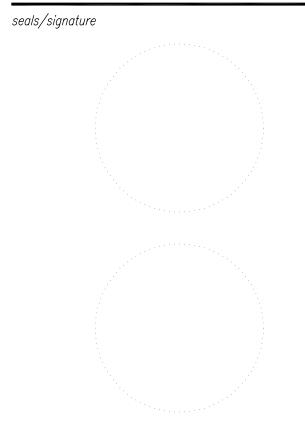

issued for CONSTRUCTION DOCUMENTS

^{date} JULY 23, 2013

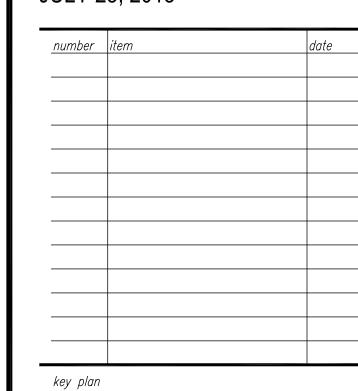


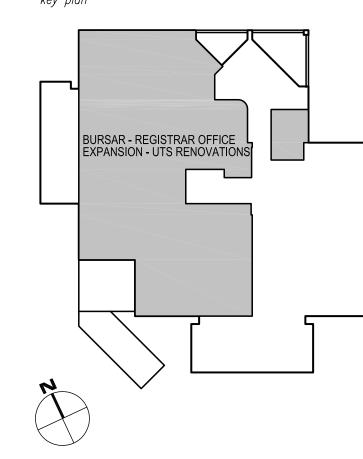

FIRST FLOOR PLUMBING **RENOVATION PLAN**

sheet number

drawn by RLW checked by JWB

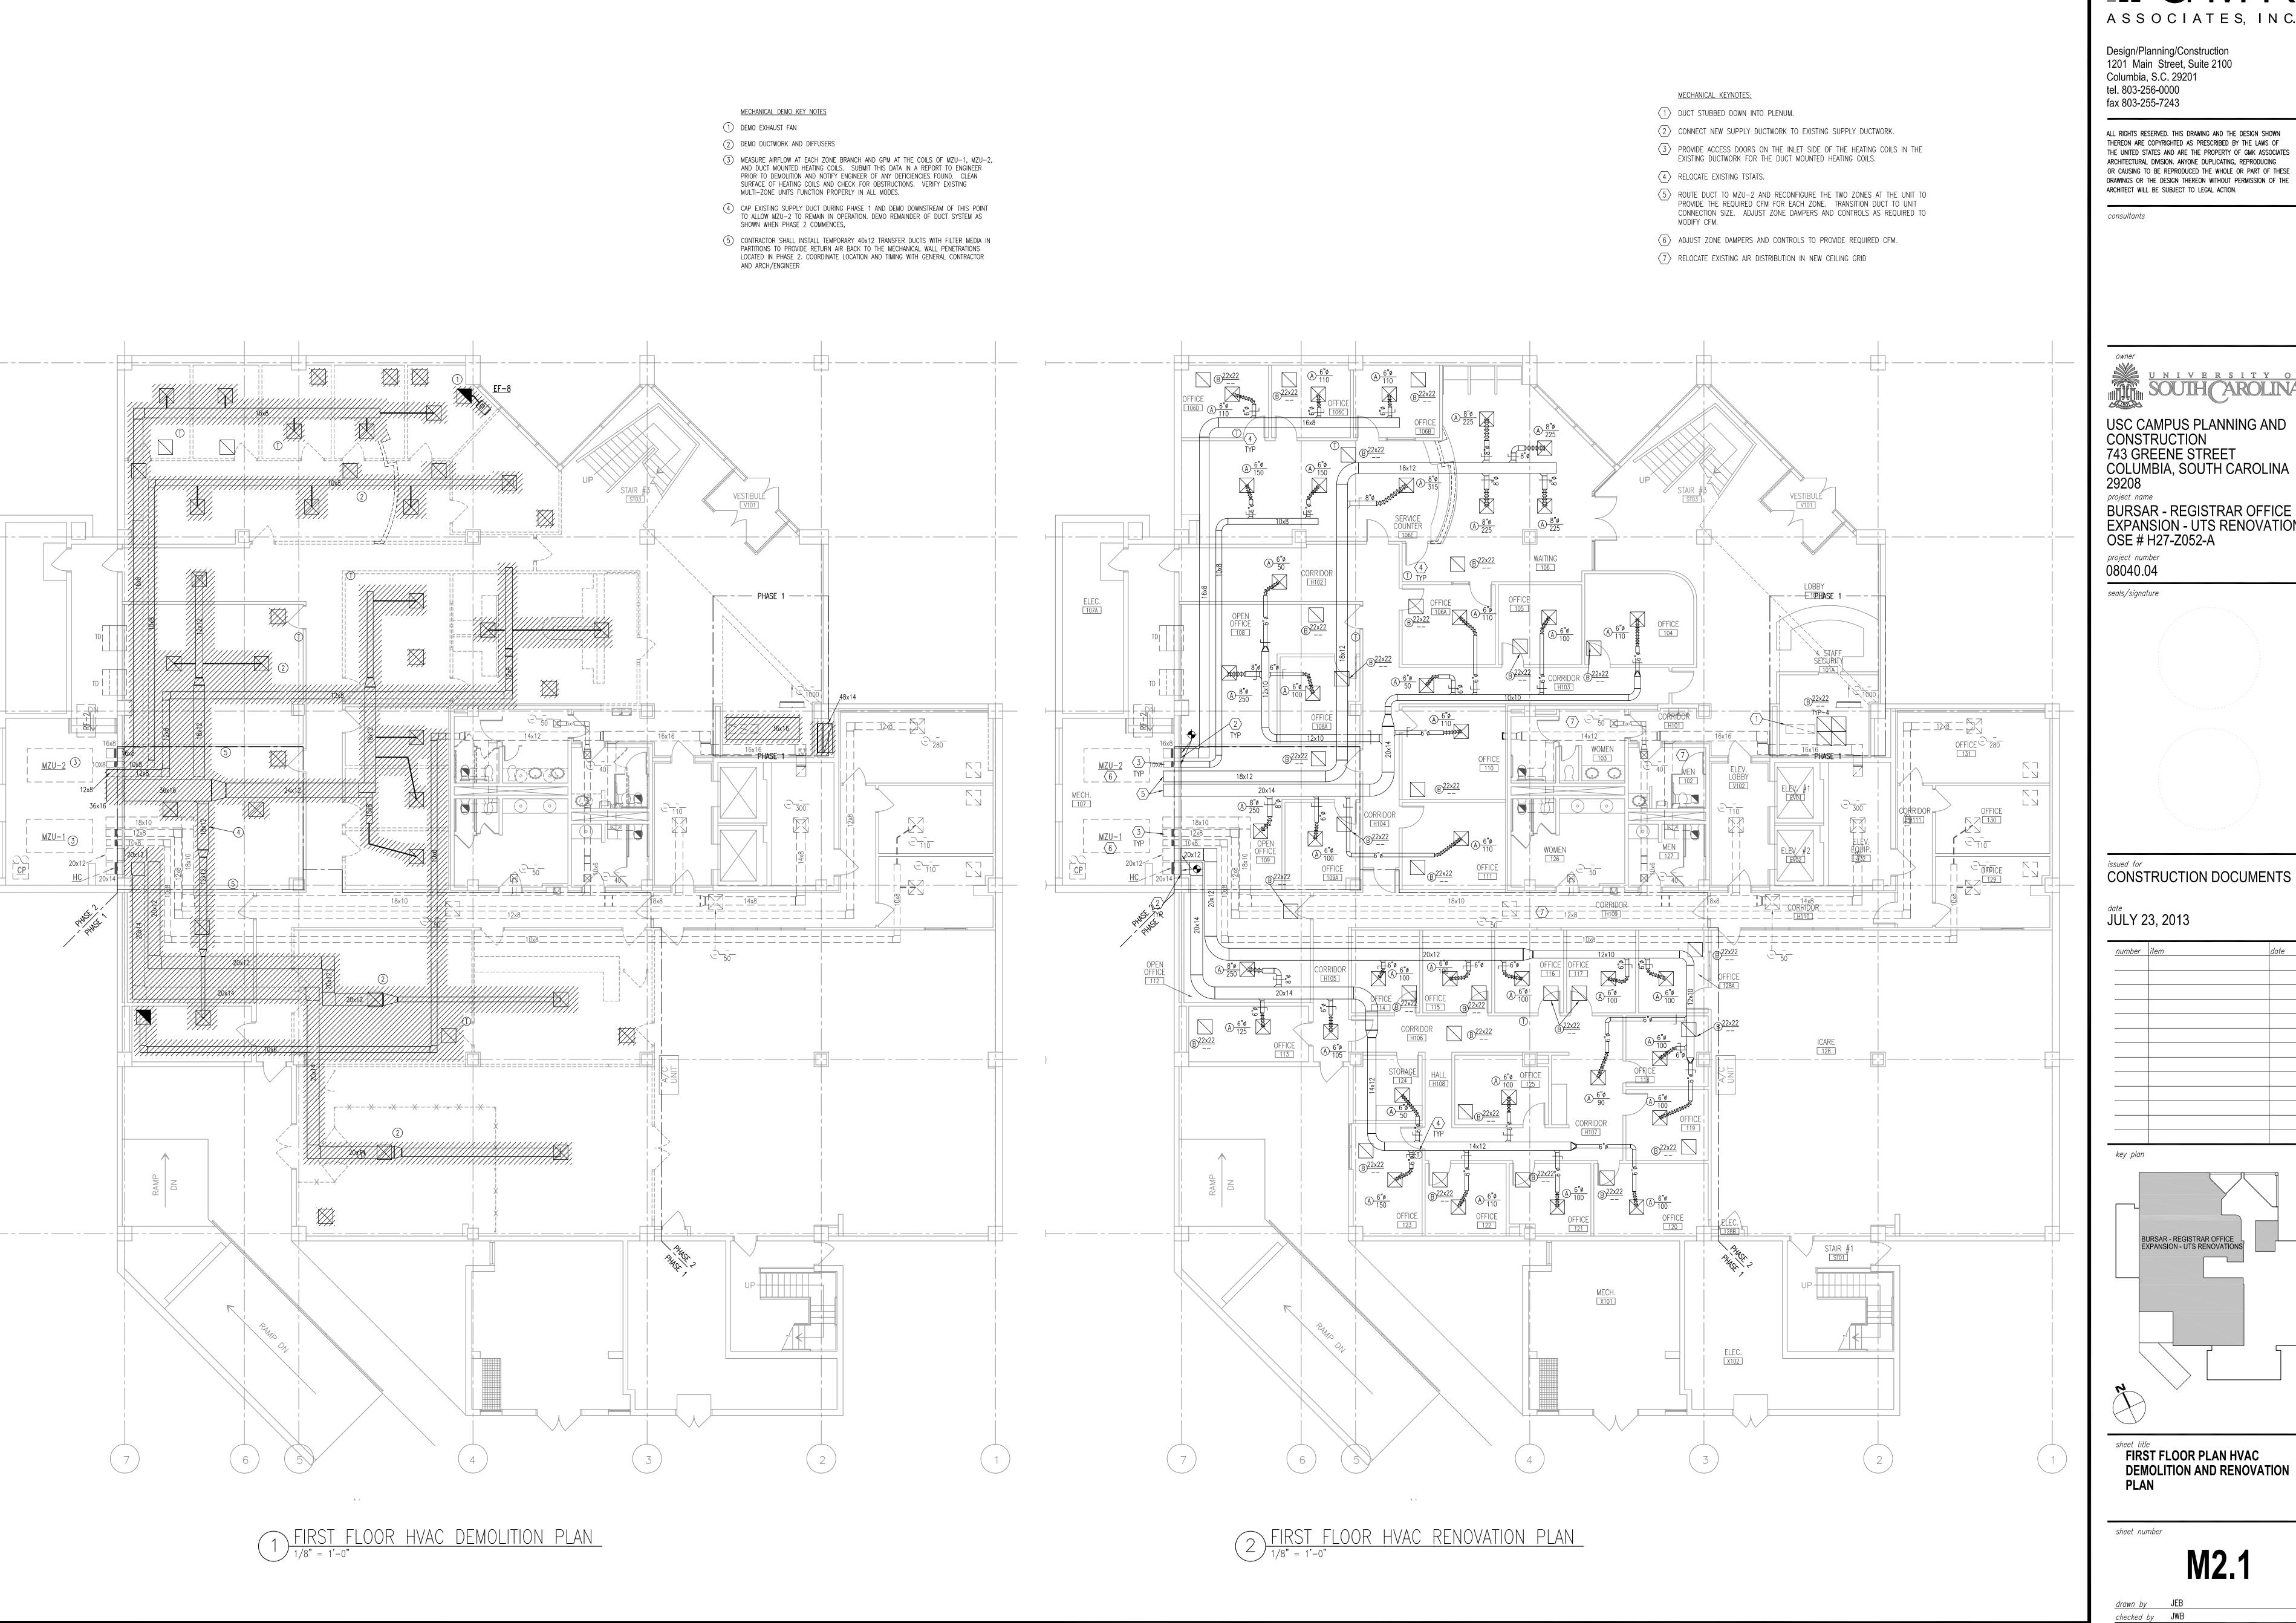

ASSOCIATES, INC.

Design/Planning/Construction 1201 Main Street, Suite 2100 Columbia, S.C. 29201 tel. 803-256-0000 fax 803-255-7243

ALL RIGHTS RESERVED. THIS DRAWING AND THE DESIGN SHOWN THEREON ARE COPYRIGHTED AS PRESCRIBED BY THE LAWS OF THE UNITED STATES AND ARE THE PROPERTY OF GMK ASSOCIATES ARCHITECTURAL DIVISION. ANYONE DUPLICATING, REPRODUCING OR CAUSING TO BE REPRODUCED THE WHOLE OR PART OF THESE DRAWINGS OR THE DESIGN THEREON WITHOUT PERMISSION OF THE ARCHITECT WILL BE SUBJECT TO LEGAL ACTION.


USC CAMPUS PLANNING AND CONSTRUCTION 743 GREENE STREET COLUMBIA, SOUTH CAROLINA project name


BURSAR - REGISTRAR OFFICE EXPANSION - UTS RENOVATIONS OSE # H27-Z052-A

08040.04

seals/signature

JULY 23, 2013

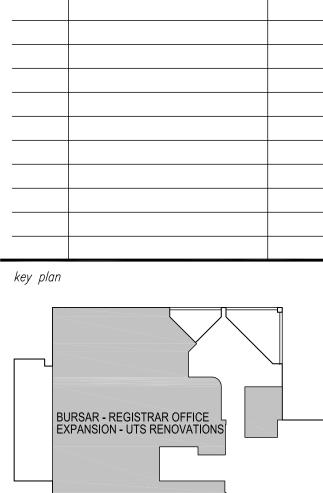

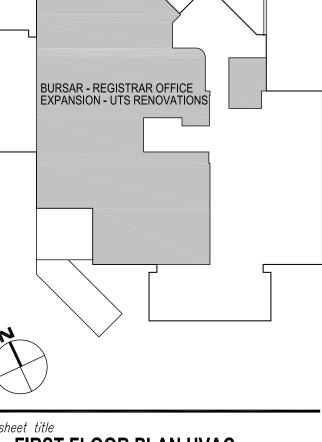

FIRST FLOOR PLAN HVAC
DEMOLITION AND RENOVATION

SUPPLY DIFFUSER RETURN DIFFUSER RETURN DIFFUSER EXHAUST DIFFUSER EXHAUST DIFFUSER EXHAUST DIFFUSER EXHAUST DIFFUSER EXHAUST DIFFUSER EXISTING DUCT WORK TO REMAIN THERMOSTAL THERMOSTAL TO CONNECT TO EXISTING RUN-OUT/FLEXIBLE DUCT BALANCING DAMPER THE CHANGE IN DUCT ELEVATION DUCT TURNING UNDUCT TURNING UND		
RETURN DIFFUSES EXHAUST DIFFUSES DUCTWORK TO BE DEMOED EXISTING DUCT WORK TO REMAIN THERMOSTA KEY NOTE DEMO KEY NOTE CONNECT TO EXISTING RUN-OUT/FLEXIBLE DUCT BALANCING DAMPER CHANGE IN DUCT ELEVATION DUCT TURNING UN DUCT TURNING UN ELBOW TURNED DOWN ISOLATION VALVE NECK SIZE	HVAC	LEGEND
DUCTWORK TO BE DEMOED EXISTING DUCT WORK TO REMAIN THERMOSTAL KEY NOTE CONNECT TO EXISTING RUN—OUT/FLEXIBLE DUCT BALANCING DAMPER CHANGE IN DUCT ELEVATION DUCT TURNING UN DUCT TURNING UN ELBOW TURNED DOWN ISOLATION VALVE NECK SIZE	\boxtimes	SUPPLY DIFFUSEI
DUCTWORK TO BE DEMOED EXISTING DUCT WORK TO REMAIN THERMOSTATION KEY NOTE DEMO KEY NOTE CONNECT TO EXISTING RUN-OUT/FLEXIBLE DUCT BALANCING DAMPER CHANGE IN DUCT TURNING DOWN DUCT TURNING UN DUCT TURNING UN ELBOW TURNED DOWN ISOLATION VALV NECK SIZE		RETURN DIFFUSEI
EXISTING DUCT WORK TO REMAIN THERMOSTA KEY NOTE DEMO KEY NOTE CONNECT TO EXISTING RUN-OUT/FLEXIBLE DUCT BALANCING DAMPER CHANGE IN DUCT ELEVATION DUCT TURNING DOWN DUCT TURNING UN ELBOW TURNED DOWN ISOLATION VALV NECK SIZE		EXHAUST DIFFUSE
THERMOSTA (1) KEY NOTI DEMO KEY NOTI CONNECT TO EXISTING RUN—OUT/FLEXIBLE DUC BALANCING DAMPER CHANGE IN DUCT ELEVATION DUCT TURNING UN DUCT TURNING UN ELBOW TURNED DOWN ISOLATION VALV —NECK SIZE	*//////	DUCTWORK TO BE DEMOEI
DEMO KEY NOTE CONNECT TO EXISTING RUN-OUT/FLEXIBLE DUC BALANCING DAMPER CHANGE IN DUCT ELEVATION DUCT TURNING UN DUCT TURNING UN ELBOW TURNED DOWN ISOLATION VALV		EXISTING DUCT WORK TO REMAI
DEMO KEY NOTE CONNECT TO EXISTING RUN-OUT/FLEXIBLE DUC BALANCING DAMPER CHANGE IN DUCT ELEVATION DUCT TURNING DOWN DUCT TURNING UN ELBOW TURNED DOWN ISOLATION VALV NECK SIZE	\bigcirc	THERMOSTA
CONNECT TO EXISTING RUN-OUT/FLEXIBLE DUCT BALANCING DAMPER CHANGE IN DUCT ELEVATION DUCT TURNING DOWN DUCT TURNING UP ELBOW TURNED DOWN ISOLATION VALV NECK SIZE	1	KEY NOT
RUN-OUT/FLEXIBLE DUCT BALANCING DAMPER CHANGE IN DUCT ELEVATION DUCT TURNING DOWN DUCT TURNING UP ELBOW TURNED DOWN ISOLATION VALV NECK SIZE	1)	DEMO KEY NOT
BALANCING DAMPER CHANGE IN DUCT ELEVATION DUCT TURNING DOWN DUCT TURNING UP ELBOW TURNED DOWN ISOLATION VALV NECK SIZE	◆	CONNECT TO EXISTING
CHANGE IN DUCT ELEVATION DUCT TURNING DOWN DUCT TURNING UP DUCT TURNING UP ELBOW TURNED DOWN ISOLATION VALV NECK SIZE		RUN-OUT/FLEXIBLE DUC
DUCT TURNING DOWN DUCT TURNING UI DUCT TURNING UI ELBOW TURNED DOWN ISOLATION VALV NECK SIZE		BALANCING DAMPE
DUCT TURNING UI DUCT TURNING UI ELBOW TURNED DOW ISOLATION VALV NECK SIZE	R	CHANGE IN DUCT ELEVATION
DUCT TURNING UP ELBOW TURNED DOW ISOLATION VALV NECK SIZE		DUCT TURNING DOW
ELBOW TURNED DOW ISOLATION VALV NECK SIZE		DUCT TURNING U
-D-ISOLATION VALV		DUCT TURNING UI
NECK SIZE		ELBOW TURNED DOW
	→ >>	ISOLATION VALV
\mathcal{L}^n		NECK SIZE
DIFFUSER, GRILLE, LOUVER——(A) 100 OR REGISTER TYPE PEAK LOAD CFM		- 100

MECHANICAL DEMOLITION NOTES

- DRAWINGS SHOW GENERAL INTENT OF DEMOLITION.
 QUANTITIES, LOCATIONS, SIZES AND EQUIPMENT ARE SHOWN TO
 INDICATE TYPE OF SYSTEM INSTALLED AND DOES NOT
 NECESSARILY REPRESENT EXACT CONDITIONS. CONTRACTOR
 SHALL FIELD VERIFY BEFORE BIDDING.
- 2. DEMOLITION OF EQUIPMENT, SYSTEMS, AND COMPONENTS SHALL INCLUDE ALL SUPPORTS, PADS, HANGERS, INSULATION, CONTROLS, STARTERS, ACCESSORIES, AND APPURTENANCES NOT REQUIRED FOR THE INSTALLATION OF THE NEW SYSTEM.
- 3. WHEN PARTIAL DEMOLITION OF A SYSTEM IS INDICATED, THE PART OF THE SYSTEM SHOWN TO REMOVED SHALL BE REMOVED TO THE ACTIVE MAIN OR BRANCH IF NOT REQUIRED FOR THE INSTALLATION OF THE NEW SYSTEM. THE ACTIVE MAIN OR BRANCH SHALL BE REPAIRED TO MATCH NEW INSTALLATION AS MUCH AS PRACTICAL. IF SYSTEM IS INSULATED, INSULATION SHALL BE PATCHED AND FINISHED REPAIR (IE: VAPOR BARRIER, COATING, ETC.)
- 4. PATCHING OF BUILDING STRUCTURES AND FINISHES SHALL PERTAIN TO ALL WALLS, FLOORS, SLABS, ROOFS, STRUCTURES, AND FINISHES. PATCHES SHALL MATCH EXISTING STRUCTURE,
- FIRE RATING AND FINISH.

 5, ALL OPENINGS CREATED BY THE ABANDONMENT OR REMOVAL
- OF EXISTING SYSTEMS SHALL BE PATCHED.

 6. ALL WALLS, ROOFS, SLABS, STRUCTURES, AND FINISHES WHOSE FINISH IS IRREGULAR DUE TO THE REMOVAL OF SYSTEMS, SUPPORTS, PADS, ACCESSORIES, AND APPURTENANCES SHALL BE PATCHED.
- 7. ALL FINISHES SHALL MATCH EXISTING FINISH. WHEN FINISH OBVIOUSLY DOES NOT MATCH EXISTING FINISH SUCH AS SHADE OF PAINT, AGE OF FINISH, ETC., THE FINISH SHALL BE APPLIED TO THE PATCH AND THE SURFACE IN ALL DIRECTIONS UNTIL A SURFACE CHANGE OF A MINIMUM OF 45 DEGREES.
- 8. REMOVAL OF SYSTEMS SHALL INCLUDE COMPLETE SYSTEM WHENEVER PRACTICAL. IF NOT, SYSTEM (IE: PIPE, CONDUIT, ETC.) SHALL BE REMOVED TO 1 INCH BELOW SURFACE.


MECHANICAL GENERAL NOTES


- 1. DO NOT SCALE DRAWINGS; SEE ARCHITECTURAL DRAWINGS AND REFLECTED CEILING PLANS FOR EXACT LOCATIONS OF DOORS, WINDOWS, CEILING, DIFFUSERS, ETC.
- ALL DUCTWORK INSULATION SHALL BE RUN CONTINUOUSLY THROUGH FLOORS, ROOFS AND PARTITIONS EXCEPT WHERE PROHIBITED BY FIRE CODES.
 LOCATE ALL THERMOSTATS 4'-0" ABOVE FINISH FLOOR; ALIGN
- 4. ALL DUCTWORK LOCATIONS SHALL BE COORDINATED WITH THE WORK UNDER OTHER DIVISIONS OF THE SPECIFICATIONS TO AVOID
- 5. CORRECT SETTINGS ON ALL BALANCING FITTINGS SHALL BE PERMANENTLY MARKED.
- 6. AIR DISTRIBUTION SYSTEMS WITH MORE THAN ONE BRANCH, OR MULTIPLE OUTLETS ON A BRANCH, SHALL HAVE VOLUME DAMPERS TO BALANCE AIR FLOWS. SPIN-IN FITTINGS ARE PERMITTED FOR CONNECTING FLEX DUCT TO BRANCH OR TRUNK DUCTS WHERE FLEX DUCTS ARE INDICATED. IF FLEX DUCT CANNOT BE CONNECTED WITH A SPIN-IN, A HARD DUCTED TAKEOFF MUST BE PROVIDED.
- 7. ALL DUCTS EXTENDING THRU EXTERIOR WALLS AND ROOFS SHALL BE FLASHED AND COUNTERFLASHED.

 8. PROVIDE ALL TRANSITIONS REQUIRED FOR INSTALLATION OF DUCT, EXHAUST FANS, AND ALL OTHER EQUIPMENT AND APPURTENANCES.
- 9. ALL DUCT IS GALVANIZED SHEET METAL EXCEPT AS NOTED.10. DUCT SIZES ARE CLEAR INSIDE DIMENSIONS.
- 11. AIR DISTRIBUTION UNITS SHALL HAVE TRIM REQUIRED FOR FINISHED SERVICE.


ABV AFF BHP CFM DB EAT ELEC EWB EXH FD FL HP HWR HWS LAT LWB MAX MBH MIN N/A	Above Above Finished Floor Brake Horsepower Cubic Feet Per Minute Dry Bulb Temperature Entering Air Temperature Electric or Electrical Entering Air Wet Bulb Exhaust Fire Damper Floor Horsepower Hot Water Return Hot Water Supply Leaving Air Temperature Leaving Air Wet Bulb Maximum Thousand BTU/Hr (thousands) Minimum Not Applicable	NIC NTS OA OBD OD PD RA RET RH SA SHT SP SPEC SPL T TEMP TSTAT TYP WB	Not in Contract Not To Scale Outside Air Opposed Blade Damper Outside Diameter Pressure Drop Return Air Return Relative Humidity Supply Air Sheet Static Pressure Specifications Supply Thermostat Temperature Thermostat Typical Wet Bulb Temperature
--	---	---	--

	AIR DISTRIBUTION SCHEDULE									
TAG	TAG DESCRIPTION NECK MODULE MOUNT CONSTR. MFGR MODEL NOTES									
Α	SQUARE PLAQUE CEILING SUPPLY	AS SHOWN	24x24	LAY-IN	ALUMINUM	PRICE	SERIES SPD	2,3,5		
В	PERFORATED CEILING RETURN/EXHAUST	AS SHOWN	24x24	LAY-IN	ALUMINUM	PRICE	APDDR	3		
С	C SIDEWALL RETURN AS SHOWN AS SHOWN SIDEWALL ALUMINUM PRICE SERIES 630DAL 1,3									
	1. FURNISH WITH OPPOSED BLADE DAMPER 3. BAKED ENAMEL OFF—WHITE FINISH 5. FACTORY INSULATED BACKPAN 2. 4-WAY DEFLECTION UNLESS NOTED OTHERWISE 4. PROVIDE RADIATION DAMPER									

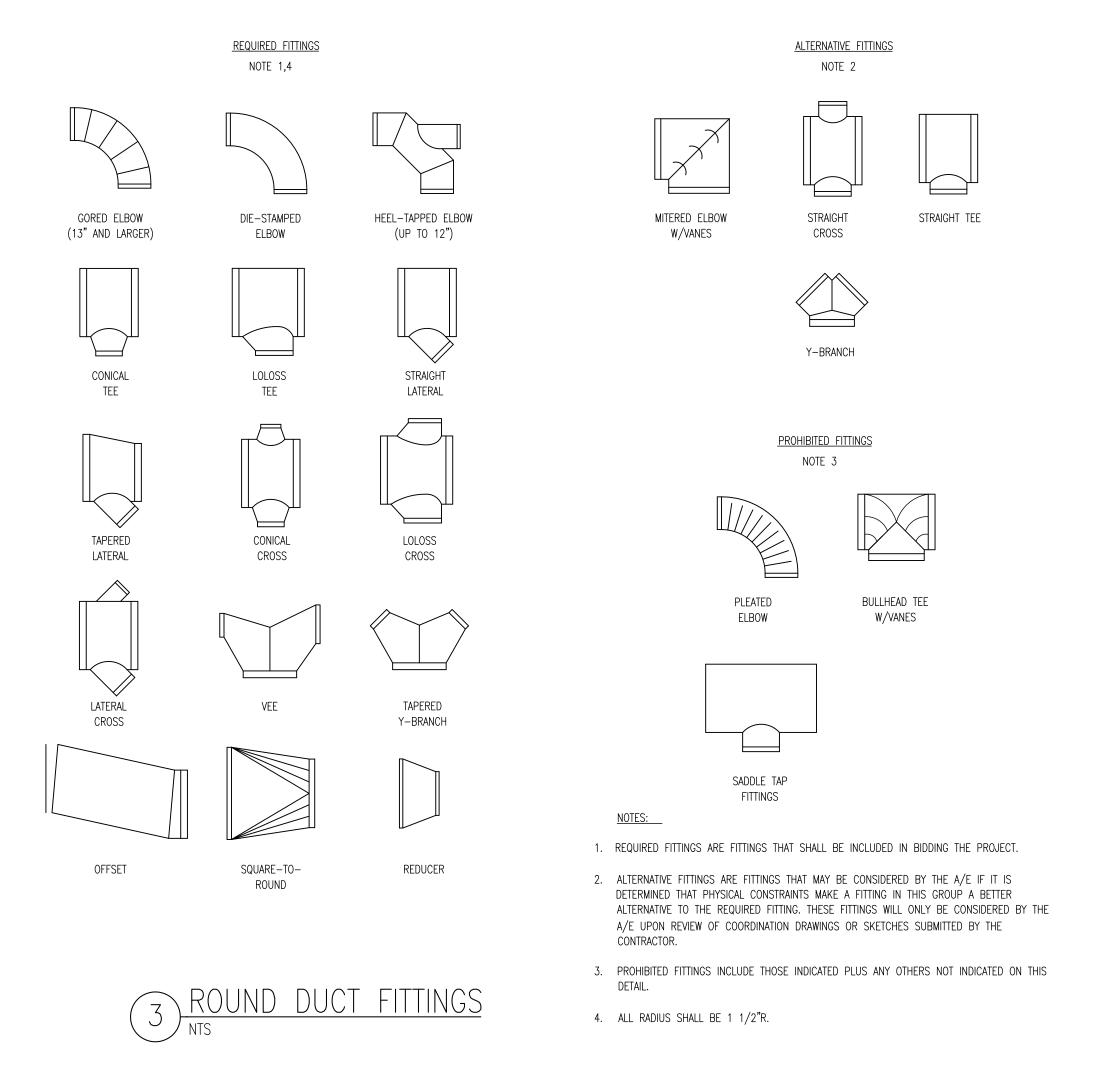

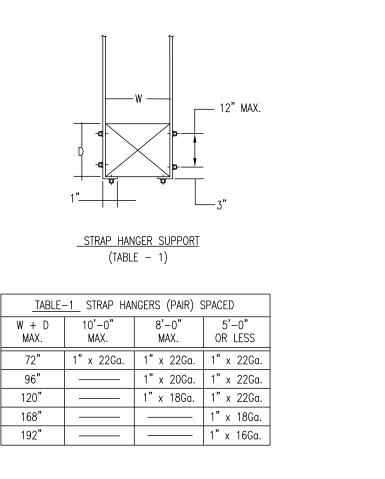

2 DUCT AND EQUIPMENT SUPPORT DETAILS

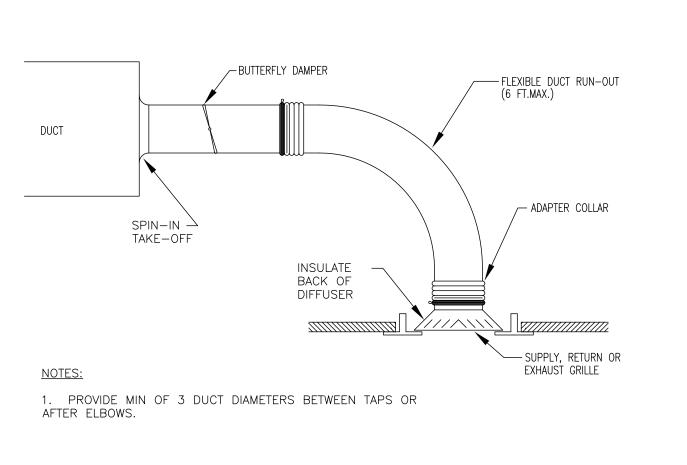



ASSOCIATES IN

A S S O C I A T E S, I N C.

Design/Planning/Construction

1201 Main Street, Suite 2100

Columbia, S.C. 29201

tel. 803-256-0000

fax 803-255-7243

ALL RIGHTS RESERVED. THIS DRAWING AND THE DESIGN SHOWN THEREON ARE COPYRIGHTED AS PRESCRIBED BY THE LAWS OF THE UNITED STATES AND ARE THE PROPERTY OF GMK ASSOCIATES ARCHITECTURAL DIVISION. ANYONE DUPLICATING, REPRODUCING OR CAUSING TO BE REPRODUCED THE WHOLE OR PART OF THESE DRAWINGS OR THE DESIGN THEREON WITHOUT PERMISSION OF THE ARCHITECT WILL BE SUBJECT TO LEGAL ACTION.

consultants

owner

UNIVERSITY OF

SOUTH CAROLINA

USC CAMPUS PLANNING AND CONSTRUCTION
743 GREENE STREET
COLUMBIA, SOUTH CAROLINA
29208
project name

BURSAR - REGISTRAR OFFICE EXPANSION - UTS RENOVATIONS OSE # H27-Z052-A


project number 08040.04


seals/signature



issued for CONSTRUCTION DOCUMENTS

^{date} JULY 23, 2013

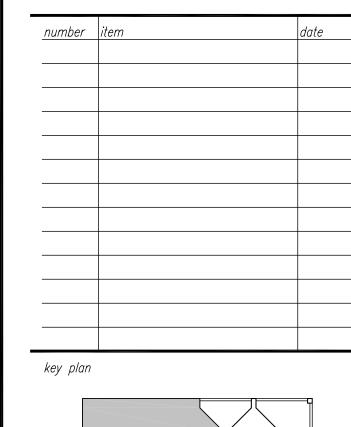

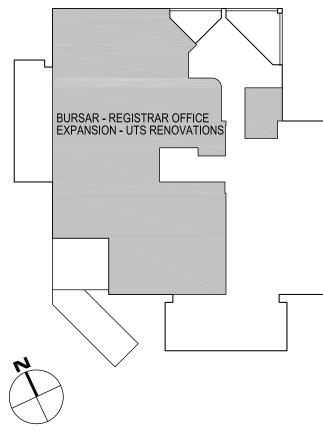


HVAC SCHEDULE AND DETAILS

sheet number


M7.1

drawn by JEB checked by JWB

System No. W-L-1001 F Rating - 1, 2, 3 and 4 Hr (See items 2 and 3) T Rating - 0, 1, 2, 3, and 4 Hr (See item 3) L Rating at Ambient - less than 1 CFM/sq. ft. L Rating at 400° F - less than 1 CFM/sq. ft.

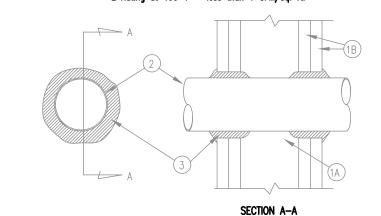


- 1. Wall Assembly The 1, 2, 3, or 4 hour fire—rated gypsum wallboard/stud wall assembly shall be constructed of the materials and in the manner described in the individual U300 or U400 Series Wall or Partition Designs in the UL Fire Resistance Directory and shall include the following construction features: A Studs - Wall framing may consist of either wood or steel channel studs. Wood studs (max 2 hour fire rated assemblies) or steel channel studs. Wood studs to consist of nom 2 by 4 in. lumber spaced 16 in. OC with nom 2 by 4 in. lumber end plates and cross braces. Steel studs to be min
- 3-5/8 in. wide by 1-3/8 in. deep channels spaced max 24 in. OC. B. Wallboard, Gypsum* - Nom 1/2 or 5/8 in. thick, 4 ft. wide with square or tapered edges. The gypsum wallboard type, thickness, number of layers, fastener type and sheet orientation shall be as specified in the individual U300 or U400 Series Design in the UL Fire Resistance Directory. Max diam
- of opening is 13-1/2 in. 2. Pipe or conduit - Nom 12 in. diam (or smaller) Schedule 10 (or heavier) steel pipe, nom 12 in. diam (or smaller) service weight (or heavier) cast iron soil pipe, nom 12 in. diam (or smaller) Class 50 (or heavier) smaller) service weight (or heavier) cast iron soil pipe, nom 12 in. diam (or smaller) Class 50 (or heavier) ductile iron pressure pipe, nom 6 in. (or smaller) steel conduit, nom 4 in. diam (or smaller) steel electrical metallic tubing, nom 6 in. diam (or smaller) Type L or (or heavier) copper tubing or nom 1 in. diam (or smaller) flexible steel conduit. When copper pipe is used, max F Rating of firestop system (Item 3) is 2 hr. Steel pipes or conduits larger than nom 4 in. diam may only be used in walls constructed using steel channel studs. A max of one pipe or conduit is permitted in the firestop system. Pipe or conduit to be installed near center of stud cavity width and to be rigidly supported on both sides of wall assembly.
- 3. Fill, Void or Cavity Material* Caulk Caulk fill material installed to completely fill annular space between pipe or conduit and gypsum wallboard and with a min 1/4 in. diam bead of caulk applied to perimeter of pipe or conduit at its egress from the wall. Caulk installed symmetrically on both sides of wall assembly. The hourly F Rating of the firestop system is DEPENDENT upon the hourly fire rating of the wall assembly in which it is installed, as shown in the following table. The hourly T rating of the firestop system is dependent upon the type or size of the pipe or conduit and the hourly fire rating of the wall assembly in which it is installed, as tabulated below:

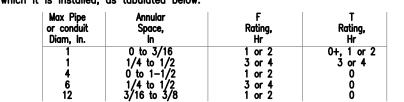

+When copper pipe is used, T Rating is 0 hr. Minnesota Mining & Mfg. Co. — CP 25WB+. *Bearing the UL Classification Marking.

System No. WL1052 F Rating - 2, 3 AND 4 Hr T Rating — 0 Hr L Rating At Ambient - 2 CFM/sq ft (See Item 4) L Rating At 400 F - less than 1 CFM/sq ft (See Item 4)

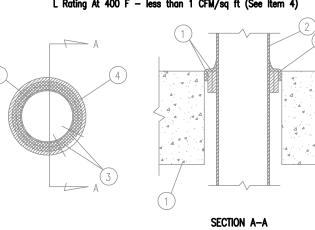


- 1. Floor or Wall Assembly Lightweight or normal weight (100—150 pcf) concrete. Min. thickness of concrete floor or wall assembly is 4—1/2 in. for 2 and 3 hr F Ratings and 5—1/2 in. for 4 hr F Rating. Wall may also be constructed of any UL Classified Concrete Blocks*. Max diam of circular opening is 13-1/2 in. See Concrete Blocks (CAZT category in the Fire Resistance Directory for names of manufacturers. 2. Steel Pipe or Conduit - Nom 12 in. diam (or smaller) Schedule 10 or heavier steel pipe, nom 6 in. diam (or smaller) steel conduit or nom 4 in. diam (or smaller) steel EMT. Max one pipe or conduit per opening, centered in opening. Min clearance between pipe or conduit and sides of through opening is 1/4 in. Max clearance between pipe or conduit and sides of through opening is 1-3/4 in for 2 hr F rating
- 3. Fill, Void or Cavity Material* Wrap Strip Nom 1/4 in. thick intumescent elastomeric material faced on one side with aluminum foil, supplied in 2 in. wide strips. For the 2 and 3 hr F Ratings, min 1 in. wide strip(s) wrapped around pipe/conduit (foil side exposed) until OD of wrap strip is equal to or max 3/16 in. less than ID of circular through opening. Wrap strip tightly bound with steel tie wire or pressure sensitive tape and slid into through opening such that the top edge of the wrap strip(s) is recessed 1/4 in. from the top surface of floor or, in wall assemblies, such that the wrap strip(s) is centered in the wall thickness. For the 4 hr F Rating, nom 2 in. wide strip(s) wrapped around pipe/conduit (foil side exposed) on each side of the floor or wall assembly until OD of wrap strip is equal to or max 3/16 in. less than ID of circular through opening. Wrap strip tightly bound with steel tie wire or pressure sensitive tape and slid into through opening on each side of floor or wall assembly such that the exposed edges are recessed 1/4 in. from the floor or wall surfaces.

and 3/4 in. for 3 and 4 hr F ratings. Pipe or conduit to be rigidly supported on both sides of floor or

Minnesota Mining & Mfg. Co. — Types FS-195, FS-195+

4. Fill, Void or Cavity Material* — Caulk — Norm 1/4 in. thickness of caulk to be applied to the exposed edges of the wrap strip and to fill all voids between the pipe/conduit and the periphery of the through opening. For 2 or 3 hour F rating in floor assemblies, caulk to be installed flush with top surface of floor. For wall assemblies and for the 4 hour F Rating in floor assemblies, caulk to be applied on both Minnesota Mining & Mfg. Co. — Types CP—25 S/L, CP—25 N/S, CP—25 WB, CP—25 WB+. (Note: L Ratings apply only when Type CP—25 WB+ caulk is used.) *Bearing the UL Classification Marking.

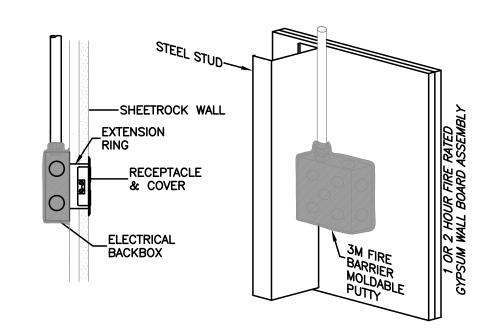


WALL OPENING PROTECTION DETAIL NTS - UL SECTION CLIV

HILTI CONSTRUCTION CHEMICALS, DIV OF HILTI INC. 5400 S 122ND EAST AVE, TULSA OK 74146 FS Pads, for use with max 4 by 4 in. flush device UL Listed Metallic Outlet Boxes in 1 and 2 hr. fire rated gypsum wallboard wall assemblies framed with min 3-5/8 in. wide steel studs and constructed as specified in the individual U400 Series Wall and Partition Designs in the Fire Resistance Directory. Min 1/8 in. thick moldable putty pads are to be installed to completely cover the exterior surfaces of the outlet box (except for the side of the outlet box against the stud) and completely seal against the stud within the stud cavity. When moldable putty pad outlet box protective material is used on boxes on both sides of wall as directed, the horizontal seperation between outlet boxes on opposite sides of the wall may be less than 24 in. provided that the boxes are not installed back to back. MINNESOTA MINING & MFG CO 3M CENTER, ST PAUL MN 55144


Type MPP-4S+ moldable putty pads for use with max 4-11/16 by 4-11/16 in. flush device UL listed

Metallic Outlet Boxes in fire rated gypsum wallboard wall assemblies framed with min 3-1/2 in. wide wood or steel studs and constructed as specified in the individual U300 or U400 Series Wall and Partition Designs in the Fire Resistance Directory. Outlet boxes secured to wood studs by means of two nailing tabs in conjunction with nails supplied with the outlet box.

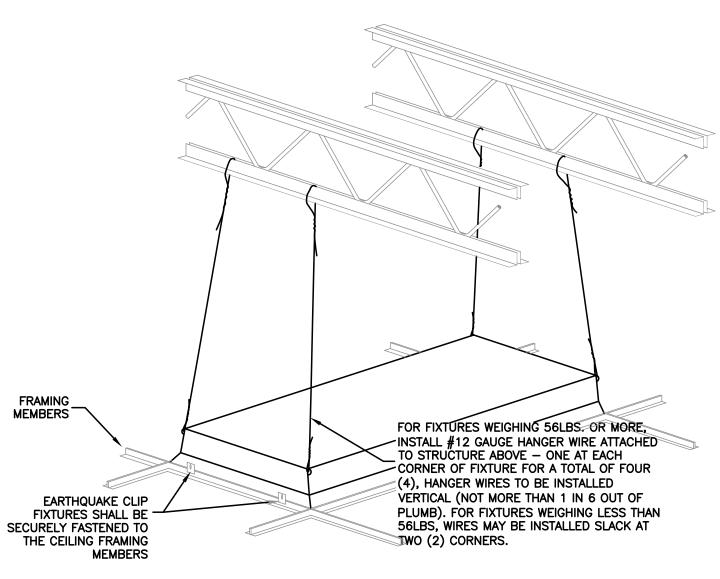

2 RECESSED LIGHTING FIXTURE DETAIL


WHERE FIXTURES ARE HUNG IN A FIRE RATED CEILING, THE CEILING CONTRACTOR SHALL PROVIDE FIRE PROTECTION AS SHOWN IN UL FIRE RESISTANCE BOOK AS DESIGN NOTE P230 OR P510.

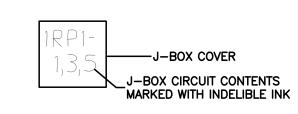

ALL EXPOSED J-BOXES, NOT INCLUDING ELECTRICAL OR MECHANICAL ROOMS, SHALL BE MARKED ON THE INSIDE COVER. ALL OTHERS SHALL BE MARKED ON THE OUTSIDE. ALL J-BOXES CONTAINING FIRE ALARM CIRCUITS SHALL BE PAINTED RED. 3 J-BOX COVER DETAIL

NTS

> ALL CONDUIT SHALL BE INSTALLED IN A
> NEAT AND ORDERLY MANNER,
> PERPENDICULAR TO ALL BUILDING WALLS
> AND BEAMS AND SHALL COMPLY STRICTLY WITH ALL CODES AND REQUIREMENTS OF THE NEC, NFPA, UL AND SBCCI WITH NO EXCEPTIONS.

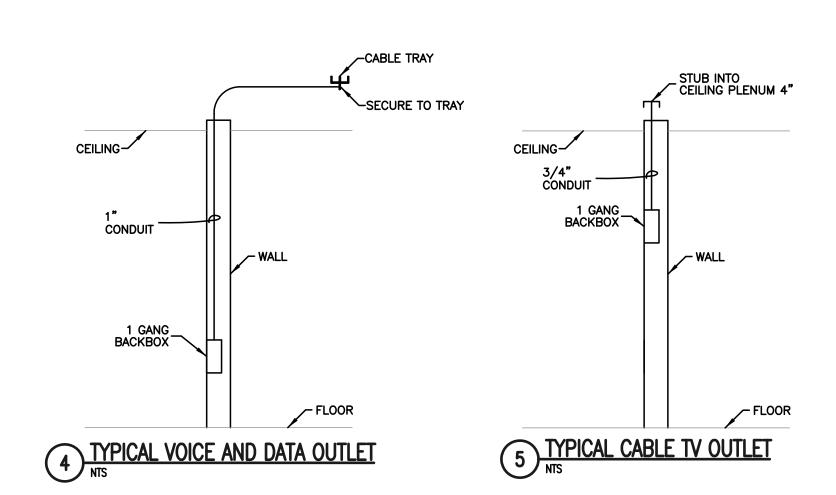

	ELECTRICAL SYN	MBOL SC	HEDULE
SYMBOL	DESCRIPTION	SYMBOL	DESCRIPTION
× LP1−2,4	BRANCH CIRCUIT RACEWAY. RUN CONCEALED IN CEILING OR WALLS. ARROWHEAD DENOTES HOMERUN TO PANEL. CROSSLINES DENOTE NUMBER OF PHASE AND NEUTRAL CONDUCTORS WHEN MAORE THAN TWO ARE TO BE INSTALLED. TEXT DENOTES PANEL NAME AND CIRCUIT NUMBERS FOR HOMERUN. INSTALL GROUND WIRE IN ALL RACEWAYS. #12 AWG MINIMUM AND AS PER CODE.	GF ⊕ WP 8	ELECTRICAL CIRCUIT BREAKER PANELBOARD. DUPLEX RECEPTACLE, 120 VOLT, 20 AMP, WALL MOUNTED, GROUND FAULT CIRCUIT INTERRUPTER, 16" AFF. THE NUMBER DENOTES CIRCUIT NUMBER. "WP" DENOTES WEATHERPROOF COVER.
ESSPOT STORAGE 1188 X 6 C H 4 \$ \$ \$ \$ \$ \$ \$ \$ \$ \$ \$ \$ \$ \$ \$ \$ \$ \$	BRANCH CIRCUIT RACEWAY. RUN IN AND/OR UNDER SLAB. ARROWHEAD DENOTES HOMERUN TO PANEL. CROSSLINES DENOTE NUMBER OF PHASE AND NEUTRAL CONDUCTORS WHEN MORE THAN TWO ARE TO BE INSTALLED. TEXT DENOTES PANEL NAME AND CIRCUIT NUMBERS FOR HOMERUN. INSTALL GROUND WIRE IN ALL RACEWAYS. #12 AWG MINIMUM AND AS PER CODE. FLEXIBLE CONDUIT. WEATHERPROOF TYPE WHEN CONNECTED TO MOTORS. CROSSLINES DENOTE NUMBER OF PHASE AND NEUTRAL CONDUCTORS WHEN MORE THAN TWO ARE INSTALLED. INSTALL GROUND WIRE WIRE #12 AWG MINIMUM. SPACE NAME AND NUMBER. COORDINATE WITH ARCHITECTURAL SPACE NUMBER. CEILING MOUNTED FLOURESCENT LIGHT FIXTURE. LETTER DENOTES TYPE OF FIXTURE IS EXISTING. SEE LIGHTING PLAN. FLUORESCENT STRIP LIGHT. LETTER DENOTES TYPE OF FIXTURE, SEE FIXTURE SCHEDULE. NUMBER DENOTES CIRCUIT NUMBER. EXIT SIGN. REFER TO FIXTURE SCHEDULE. DARKENED AREA DENOTES SIGN FACE. NUMBER DENOTES CIRCUIT NUMBER. STEM DESIGNATES WALL MOUNTING. NO STEM DENOTES CEILING MOUNTED. DOUBLE FACED EXIT SIGN. NOTATION SAME AS ABOVE. ARROWS DENOTE EXIT DIRECTION. LIGHT SWITCH, SPST, 20A, 48" AFF. DIMMER SWITCH, 1500 WATTS, 48" AFF. DIMMER SWITCH, 1500 WATTS, 48" AFF. DIMMER SWITCH, 1500 WATTS, 48" AFF. DENOTES THAT ELECTRICAL DEVICE IS SURFACE MOUNTED.	## 8 ## 8 ## 8 □ **P □ ·*P	DUPLEX RECEPTACLE, 120 VOLT, 20 AMP, WALL MOUNTED. THE NUMBER DENOTES CIRCUIT NUMBER. "GF" DENOTES GFCI RECEPTACLE. 2 — 120 VOLT, 20 AMP DUPLEX RECEPTACLES, WALL MOUNTED, 16" AFF, UNLESS OTHERWISE NOTED. THE NUMBER DENOTES CIRCUIT NUMBER. 2 — 120 VOLT, 20 AMP DUPLEX RECEPTACLES, WALL MOUNTED. THE NUMBER DENOTES CIRCUIT NUMBER "GF" DENOTES GFCI RECEPTACLE. FLUSH WALL MOUNTED JUNCTION BOX, SIZED PER NEC. "WP" DENOTES NEMA 3R WEATHERPROOF. PROVIDE AND INSTALL A FLUSH COVER PLATE. JUNCTION BOX, MOUNTED ABOVE CEILING, SIZED PER NEC. REFER TO THE NEC TO MAINTAIN CLEARANCES. CABLE TRAY, MOUNTED ABOVE CEILING. SEE SPECIFICATIONS. ALL CONDUIT PENETRATIONS THRU FIRE/SMOKE WALLS FROM ON SECTION OF TRAY TO ANOTHER SHALL BE BONDED TOGETHER. ALL SECTIONS OF CABLE TRAY AND BRANCHES SHALL BE BONDED TOGETHER.
	COMMUNICATIONS/SIGNAL	A	ABBREVIATIONS AMPERE.
	SINGLE PORT VOICE OUTLET RECEPTACLE. FLUSH WALL MOUNTED, 16" AFF. TWO PORT COMBINATION TELEPHONE AND DATA OUTLET RECEPTACLE, FLUSH WALL MOUNTED. SINGLE GANG, 16". DOT TWO PORT COMBINATION TELEPHONE AND DATA OUTLET RECEPTACLE SAME AS ABOVE, EXCEPT MOUNTED 48" AFF OR HIGHER. SINGLE GANG DATA OUTLET. FLUSH WALL MOUNTED, 16" AFF. SINGLE GANG DATA OUTLET. FLUSH WALL MOUNTED, 48" AFF OR HIGHER. TV OUTLET. FLUSH MOUNTED. TWO GANG BOX, SINGLE GANG PLASTER RING. MOUNT 66" AFF BESIDE RECEPTACLE. FIRE ALARM ANNUNCIATOR, FLUSH MOUNTED. FIRE ALARM CONTROL UNIT, WALL MOUNTED. FIRE ALARM PULL STATION, WALL MOUNTED 48" AFF. SECURITY CARD SWIPE, WALL MOUNTED.	AFF ATS BKR C CKT E CKT E ECF FCUC GF BOX KW MAX MC MDP VFD NEC SWBD YFM XFMR	ABOVE FINISHED FLOOR. AUTOMATIC TRANSFER SWITCH BREAKER. CONDUIT. CIRCUIT. EXISTING ELECTRICAL CONTRACTOR, DIVISION 16. EXHAUST FAN. FAN COIL UNIT. GENERAL CONTRACTOR, DIVISION 00 THROUGH 14. GROUND FAULT CIRCUIT INTERRUPTER. JUNCTION BOX. KILOVOLT AMPERES. KILOWATT. MAXIMUM. MECHANICAL CONTRACTOR, DIVISION 15. MAIN DISTRIBUTION PANEL. MINIMUM. VOLT. VARIABLE FREQUENCY DRIVE 2011 NATIONAL ELECTRICAL CODE. (NFPA 70). SWITCHBOARD. TYPICAL. WATER COOLER. TRANSFORMER.

	LIGHT FIXTURE SCHEDULE								
	TYPE	DESCRIPTION	CATALOG NO.	LAMPS					
	A2	2'X4', 2 LAMP TROFFER WITH SILVER PARABOLIC LOUVERS. 120 VOLT.	COLUMBIA P424-232G-MA48-S-EU-PAF 120 VOLT	2-F32T8/SPX41					
	A3	2'X4', 2 LAMP TROFFER WITH SILVER PARABOLIC LOUVERS. 2-1 LAMP BALLAST. 1-1 LAMP BALLAST ON EMERGENCY CIRCUIT. 120 VOLT.	COLUMBIA P424-232G-MA48-S-EU-2/1PAF 120 VOLT	2-F32T8/SPX41					
	A4	FLUORESCENT, 2' x 4', 2 LAMP, RECESSED STATIC TROFFER, NO PRE PAINT. 120 VOLT.	COLUMBIA 4PS24—232G—FAA12—EU—PAF 120 VOLT	2-F32T8/SPX41					
A	A 5	FLUORESCENT, 2' x 4', 2 LAMP, RECESSED STATIC TROFFER, NO PRE PAINT. 2-1 LAMP BALLAST. 1-1 LAMP BALLAST ON EMERGENCY CIRCUIT. 120 VOLT. 120 VOLT.	COLUMBIA 4PS24-232G-FAA12-EU-2/1PAF 120 VOLT	2-F32T8/SPX41					
	K	FLUORESCENT, ROUND, 8" RECESSED COMPACT FLOURESCENT DOWNLIGHT, 1-42W LAMP, CLEAR ALZAK REFLECTOR. 120V	CAPRI CM8-F142-U-H85 120 VOLT	1-CFQ42W/G24					
0	K1	FLUORESCENT, ROUND, 8" RECESSED COMPACT FLOURESCENT DOWNLIGHT, 1-26W LAMP, CLEAR ALZAK REFLECTOR. 120V	CAPRI CM8-F126-U-H85 120 VOLT	1-CFM26W/GX24					
	Р	TRIM, LOW-PROFILE UNDERCABINET LIGHT FIXTURE 120 VOLT.	LITHONIA UC42E-120-LPWW-PAF 120 VOLT	2-13W T5					
EXIT	⊗ \	EXIT LIGHT. SEE PLANS TO DETERMINE WHICH UNITS ARE SINGLE / DOUBLE FACED WALL OR CEILING MOUNTED. WALL MOUNTED EXIT LIGHTS SHALL BE MOUNTED AT 6" ABOVE TOP OF DOOR FRAME. LED.	MCPHILBEN #CXL-3-R-W 120 VOLT INPUT	LED					
NOTE #1: ALL RECESSED LIGHT FIXTURES SHALL BE HUNG WITH 4 HANGER WIRES SO THAT THE WEIGHT IS INDEPENDENT OF THE CEILING GR ALL RECESSED FIXTURES SHALL BE INSTALLED WITH EARTHQUAKE CLIPS. ALL 2' AND 4' FLUORESCENT FIXTURES SHALL BE EQUIPF WITH T8 LAMPS AND ELECTRONIC BALLASTS, UNLESS OTHERWISE NOTED. COORDINATE FIXTURE LOCATIONS WITH THE REFLECTED CEILING PLAN AND THE HVAC PLAN. ALL HID AND FLUORESCENT LIGHT FIXTURES INSTALLED OUTDOORS OR EXPOSED TO COLD WEATHER SHALL HAVE ZERO DEGREE BALLASTS. THE NUMBER AFTER THE FIXTURE CATALOG NUMBER DENOTES NUMBER OF BALLASTS (EXAMPLE: 1/4 DENOTES 1 - 4 LAMP BALLASTYPE "A" FIXTURES THAT ARE DOUBLE SWITCHED SHALL HAVE 2, 2 LAMP BALLASTS.									

ASSOCIATES, INC.

Design/Planning/Construction 1201 Main Street, Suite 2100 Columbia, S.C. 29201 tel. 803-256-0000 fax 803-255-7243

ALL RIGHTS RESERVED. THIS DRAWING AND THE DESIGN SHOWN THEREON ARE COPYRIGHTED AS PRESCRIBED BY THE LAWS OF THE UNITED STATES AND ARE THE PROPERTY OF GMK ASSOCIATES ARCHITECTURAL DIVISION. ANYONE DUPLICATING, REPRODUCING OR CAUSING TO BE REPRODUCED THE WHOLE OR PART OF THESE DRAWINGS OR THE DESIGN THEREON WITHOUT PERMISSION OF THE ARCHITECT WILL BE SUBJECT TO LEGAL ACTION.

consultants




USC CAMPUS PLANNING AND CONSTRUCTION 743 GREENE STREET COLUMBIA, SOUTH CAROLINA project name

BURSAR - REGISTRAR OFFICE **EXPANSION - UTS RENOVATIONS** OSE # H27-Z052-A


project number 08040.04

seals/signature

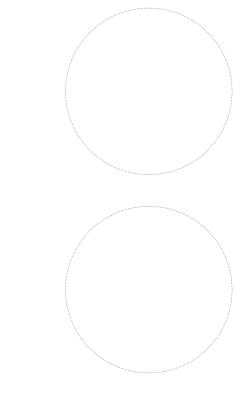

CONSTRUCTION DOCUMENTS


JULY 23, 2013

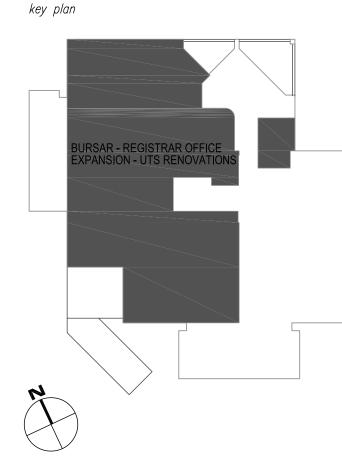

ELECTRICAL SYMBOLS, SCHEDULES, AND DETAILS

sheet number

drawn by TLK checked by JBF

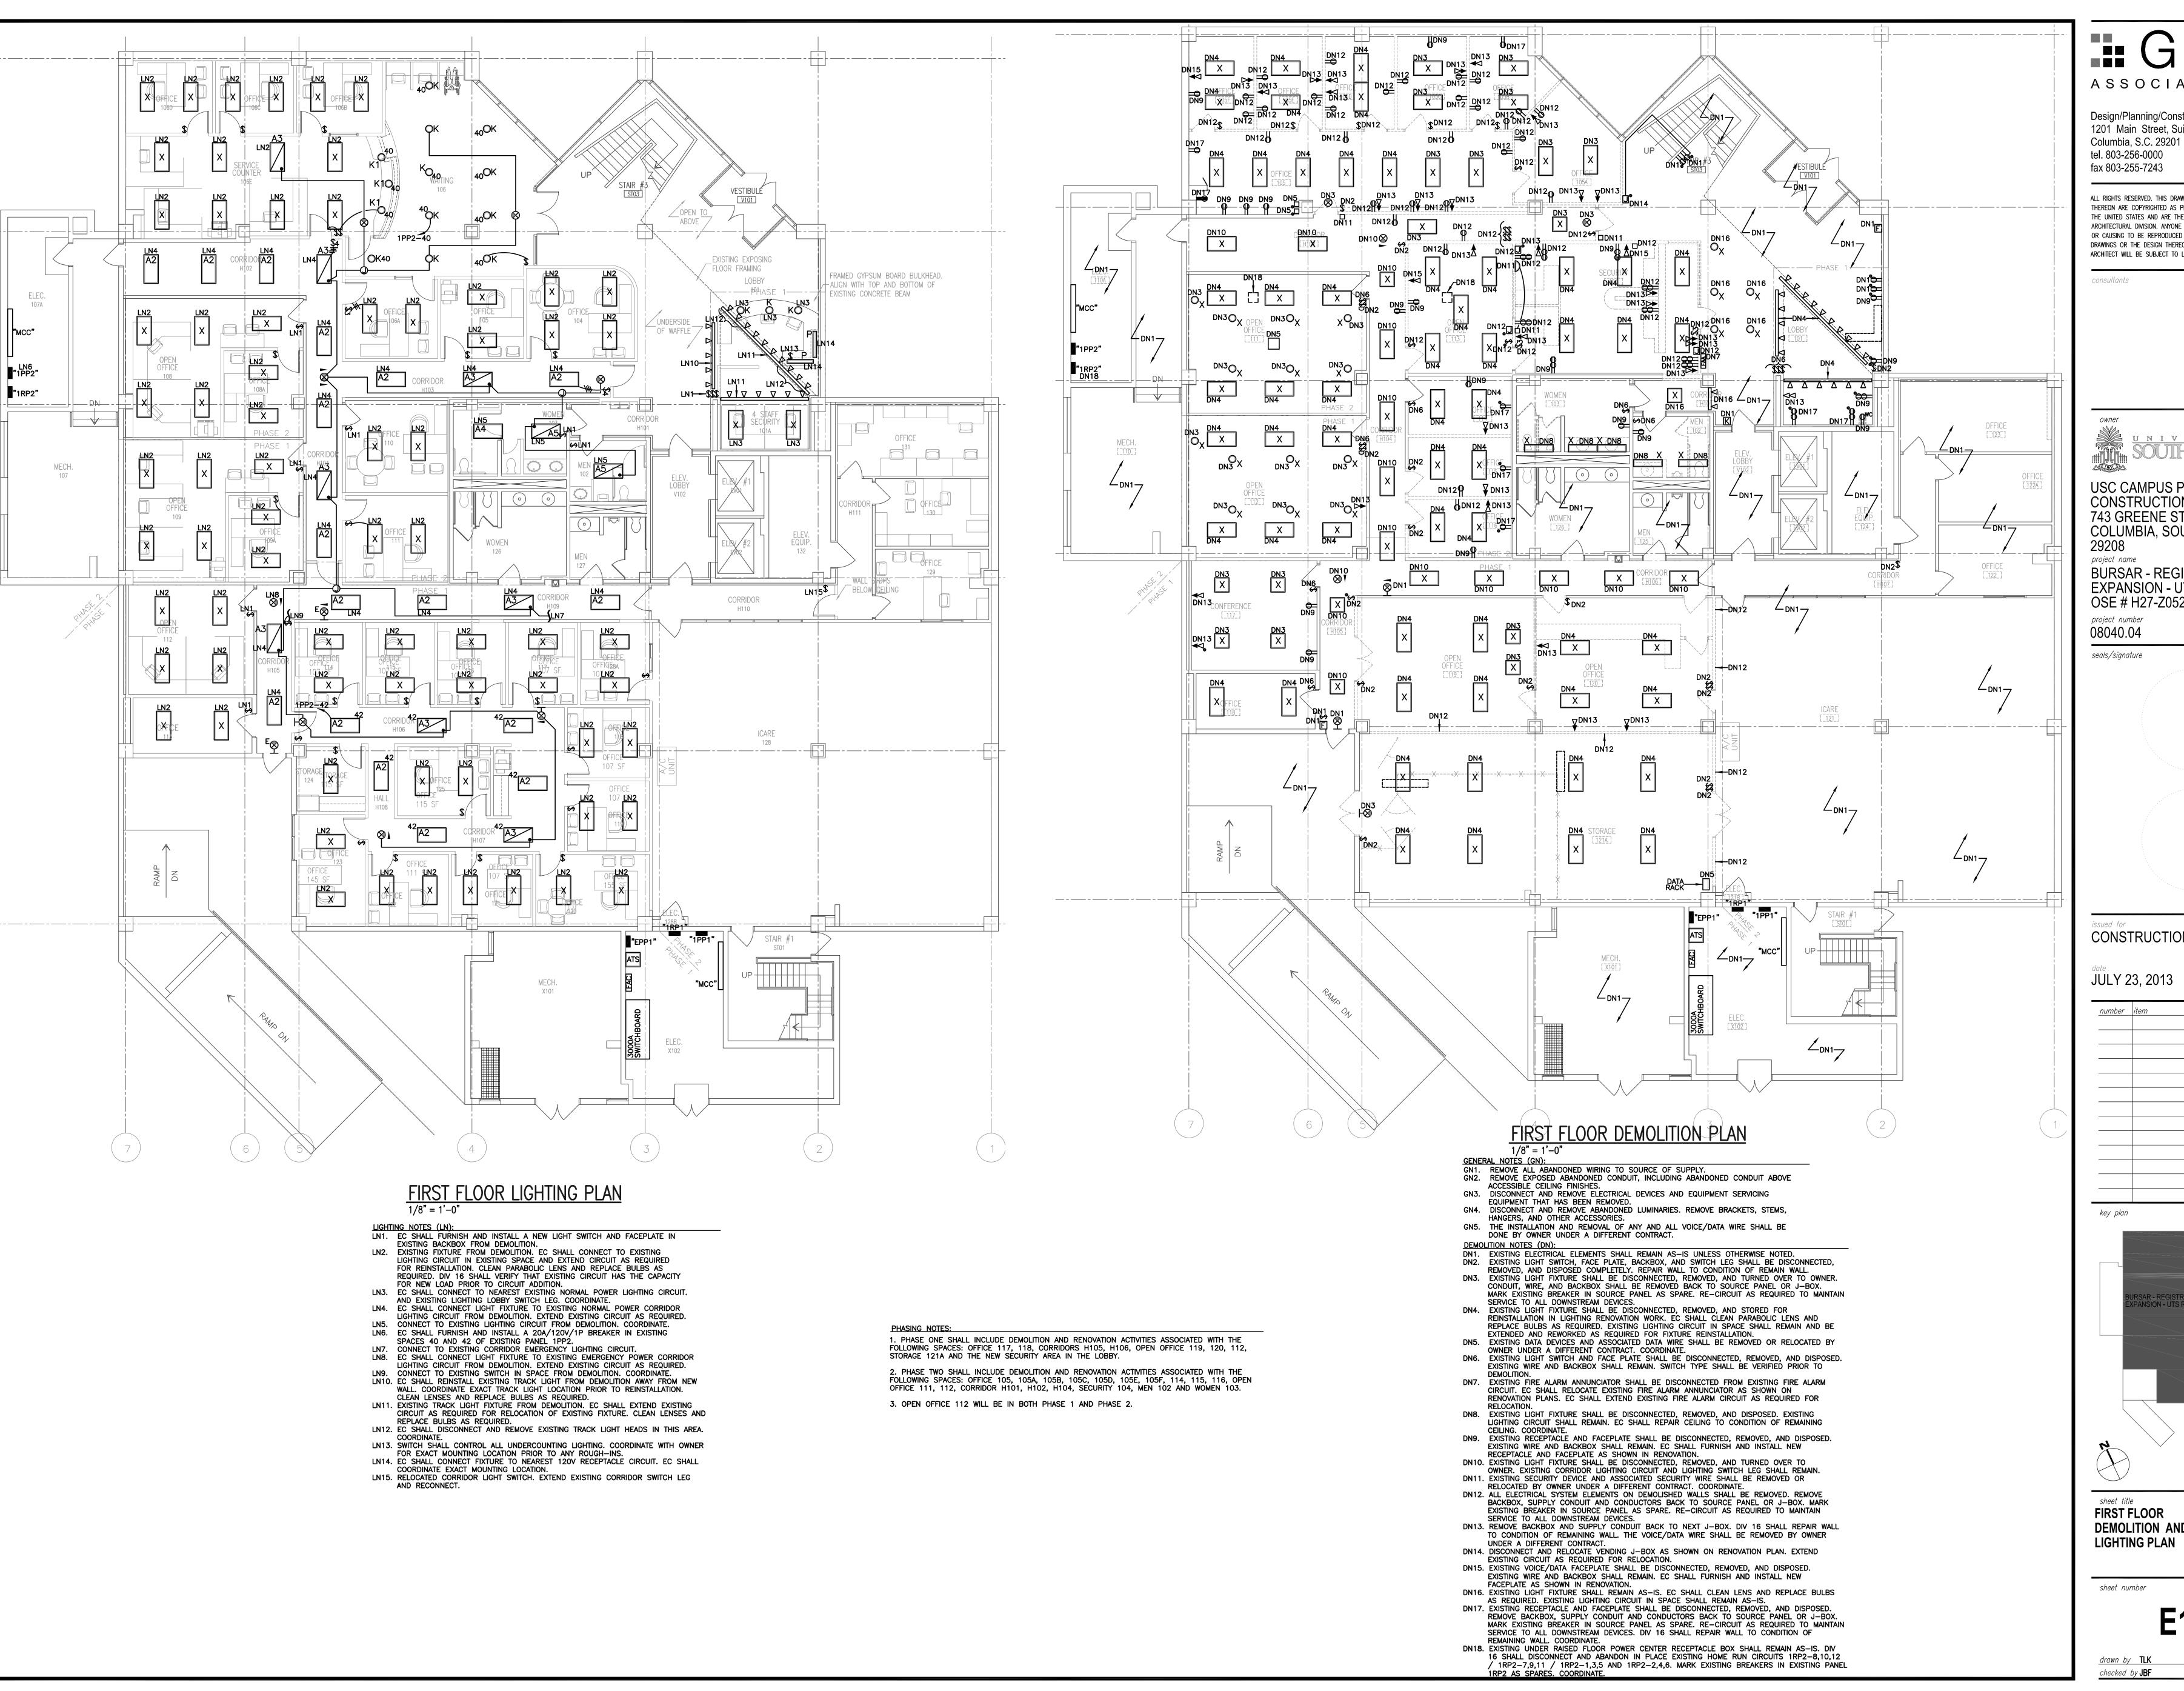

ASSOCIATES, INC.


Design/Planning/Construction 1201 Main Street, Suite 2100

ALL RIGHTS RESERVED. THIS DRAWING AND THE DESIGN SHOWN THEREON ARE COPYRIGHTED AS PRESCRIBED BY THE LAWS OF THE UNITED STATES AND ARE THE PROPERTY OF GMK ASSOCIATE ARCHITECTURAL DIVISION. ANYONE DUPLICATING, REPRODUCING OR CAUSING TO BE REPRODUCED THE WHOLE OR PART OF THESE DRAWINGS OR THE DESIGN THEREON WITHOUT PERMISSION OF THE ARCHITECT WILL BE SUBJECT TO LEGAL ACTION.

USC CAMPUS PLANNING AND CONSTRUCTION 743 GREENE STREET COLUMBIA, SOUTH CAROLINA

BURSAR - REGISTRAR OFFICE EXPANSION - UTS RENOVATIONS OSE # H27-Z052-A


CONSTRUCTION DOCUMENTS

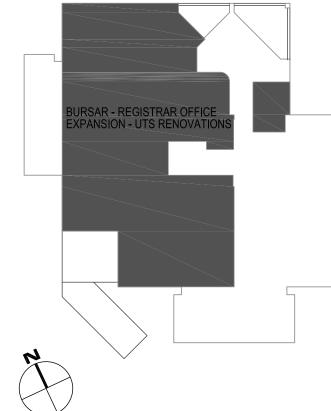

FIRST FLOOR **DEMOLITION AND** LIGHTING PLAN

sheet number

drawn by **TLK**

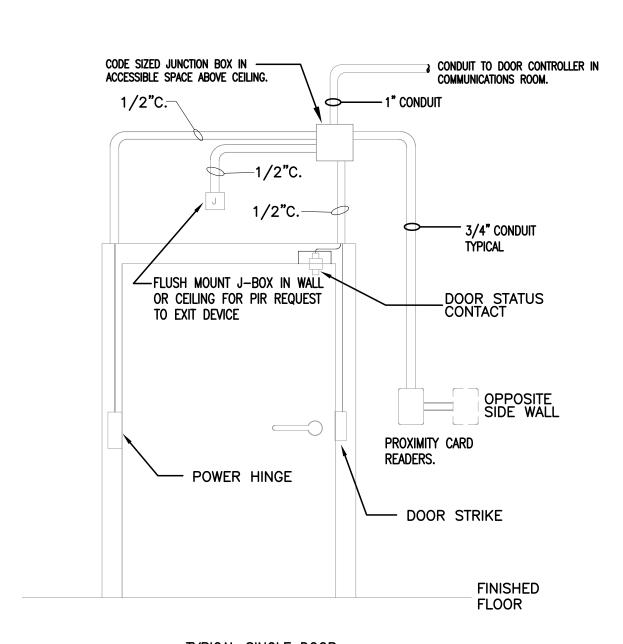

TYPICAL SINGLE DOOR

TYPICAL SECURITY DOOR ACCESS CONTROL DETAIL SCALE: NTS

SECURITY DOOR DETAILS NOTES:

- 1. THE DOOR CONTROLLER, DOOR LOCK, STATUS SWITCH, PROXIMITY CARD READERS AND PIR EXIT DEVICES SHALL BE PROVIDED AND INSTALLED BY THE SECURITY CONTRACTOR AND DOOR HARDWARE PROVIDER. THIS ALSO INCLUDES WIRING. THE ELECTRICAL CONTRACTOR INSTALL ALL RACEWAYS AS SHOWN TO SUPPORT WIRING, DEVICE AND HARDWARE INSTALLATION.
- 2. THE HARDWARE AND DEVICES PROVIDED FOR EACH DOOR MAY VARY. KEYPADS OR PIR DEVICES MAY BE USED IN LIEU OF PROXIMITY CARD READERS AND MAGNETIC LOCKS MAY BE USED INSTEAD OF POWER HINGES. SOME DOORS MAY HAVE KEYPADS OR CARD READERS ON ONE SIDE AND PUSH BUTTONS OR PUSH PADS ON THE OTHER SIDE. PIR EXIT DEVICES MAY BE CEILING OR WALL MOUNTED. OBTAIN DETAIL OF EACH DOOR PRIOR TO BEGINNING WORK AND PROVIDE RACEWAYS SUITABLE FOR EACH SITUATION.
- 3. SEE THE FLOOR PLANS FOR THE IDENTIFICATION OF SECURITY ACCESS DOORS.



FIRST FLOOR POWER PLAN 1/8" = 1'-0"

POWER NOTES (PN):

PN1. EXISTING RECEPTACLE FROM DEMOLITION. EC SHALL FURNISH AND INSTALL A NEW RECEPTACLE, FACEPLATE, AND CONNECT TO EXISTING CIRCUIT IN BACKBOX.

PN2. EXISTING VOICE/DATA OUTLET FROM DEMOLITION. EC SHALL FURNISH AND INSTALL A NEW FACEPLATE. COORDINATE.

PN3. EXISTING RELOCATED FIRE ALARM ANNUNCIATOR FROM DEMOLITION. EC SHALL EXTEND EXISTING FIRE ALARM CIRCUIT AS REQUIRED FOR REINSTALLATION.

PN4. EC SHALL COORDINATE HEIGHT AND LOCATION OF ELECTRICAL DEVICES WITH MILLWORK INSTALLATION DRAWINGS PRIOR TO ANY ROUGH—INS. CONNECT TO THE NEAR NORMAL POWER RECEPTACLE CIRCUIT FROM DEMOLITION. COORDINATE.

PN5. EC SHALL FURNISH AND INSTALL A 20A/120V/1P BREAKER IN EXISTING

SPACES 33,34,35,36,37,38,39,40,41 AND 42 OF EXISTING PANEL 1RP2.

PN6. EXISTING VENDING J-BOX FROM DEMOLITION. DIV 16 SHALL EXTEND EXISTING CIRCUIT AS REQUIRED FOR RELOCATION. COORDINATE.

PN7. 4"C SLEEVE WITH GROMMETED ENDS ABOVE CEILING FOR DATA CABLES.

PN8. RECEPTACLE SHALL BE A 30A/1P LOCKING RECEPTACLE. TYPE L6—30R. EC SHALL

COORDINATE EXACT LOCATION OF RECEPTACLE WITH OWNER.

PN9. RECEPTACLE SHALL BE A 20A/1P LOCKING RECEPTACLE. TYPE L5-20R. EC SHALL COORDINATE EXACT LOCATION OF RECEPTACLE WITH OWNER.

PN10. CONNECT TO COMMUNICATIONS GROUNDING BUS BAR. COORDINATE EXACT LOCATION.
PN11. SEE TYPICAL DOOR SECURITY ACCESS CONTROL DOOR DETAIL THIS SHEET.

key plan

BURSAR - REGISTRAR OFFICE EXPANSION - UTS RENOVATIONS

ASSOCIATES, INC.

ALL RIGHTS RESERVED. THIS DRAWING AND THE DESIGN SHOWN THEREON ARE COPYRIGHTED AS PRESCRIBED BY THE LAWS OF

THE UNITED STATES AND ARE THE PROPERTY OF GMK ASSOCIATES

USC CAMPUS PLANNING AND

COLUMBIA, SOUTH CAROLINA

BURSAR - REGISTRAR OFFICE

CONSTRUCTION DOCUMENTS

JULY 23, 2013

EXPANSION - UTS RENOVATIONS

CONSTRUCTION

OSE # H27-Z052-A

29208

project name

project number 08040.04

seals/signature

743 GREENE STREET

ARCHITECTURAL DIVISION. ANYONE DUPLICATING, REPRODUCING OR CAUSING TO BE REPRODUCED THE WHOLE OR PART OF THESE DRAWINGS OR THE DESIGN THEREON WITHOUT PERMISSION OF THE

ARCHITECT WILL BE SUBJECT TO LEGAL ACTION.

Design/Planning/Construction 1201 Main Street, Suite 2100

Columbia, S.C. 29201 tel. 803-256-0000 fax 803-255-7243


consultants

sheet title
FIRST FLOOR
POWER PLAN

sheet numb

E3.

drawn by TLK
checked by JBF

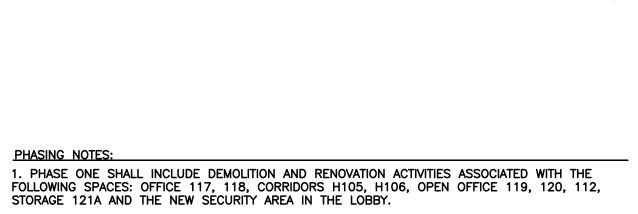

2. PHASE TWO SHALL INCLUDE DEMOLITION AND RENOVATION ACTIVITIES ASSOCIATED WITH THE

3. OPEN OFFICE 112 WILL BE IN BOTH PHASE 1 AND PHASE 2.

FOLLOWING SPACES: OFFICE 105, 105A, 105B, 105C, 105D, 105E, 105F, 114, 115, 116, OPEN OFFICE 111, 112, CORRIDOR H101, H102, H104, SECURITY 104, MEN 102 AND WOMEN 103.